




REPRODUCTION, DISCLOSURE, OR USE WITHOUT SPECIFIC WRITTEN AUTHORIZATION IS STRICTLY FORBIDDEN




SITE PLAN RE RE D m 4 S PARCEL SOL Ζ ド AND CREI 4 GН ARE. VANDERBUR SS USE BLUEGRA SPECIAL


PROJECT DETAILS


LATITUDE	38.122627
LONGITUDE	-87.475851
INTERCON. VOLTAGE	69 KV
LEASED AREA	878.1 ACRES
FENCED AREA	604.0 ACRES
FENCE LENGTH	88,408 LF
WIND LOAD	105 MPH ASCE 7-10
SNOW LOAD	15 PSF ASCE 7-10
DC CAPACITY	153,581.4 KW
AC CAPACITY	100,000.0 KW
DC:AC RATIO	1.536
STRUCTURE	NEXTRACKER (72 & 48 MODS/ROW)
TRACKER ROWS	(2,989 X 72); (894 X 48)
AZIMUTH	180 DEGREES
GCR	40.0%
MODULE	Q.PEAK DUO XL-G11
MODULE CAPACITY	595W
MODULE QUANTITY	258,120
STRING SIZE	24
INVERTER	SUNGROW SG4400UD-MV-US
INVERTER CAPACITY	4,400 KVA @ 40C
INVERTER QUANTITY	28

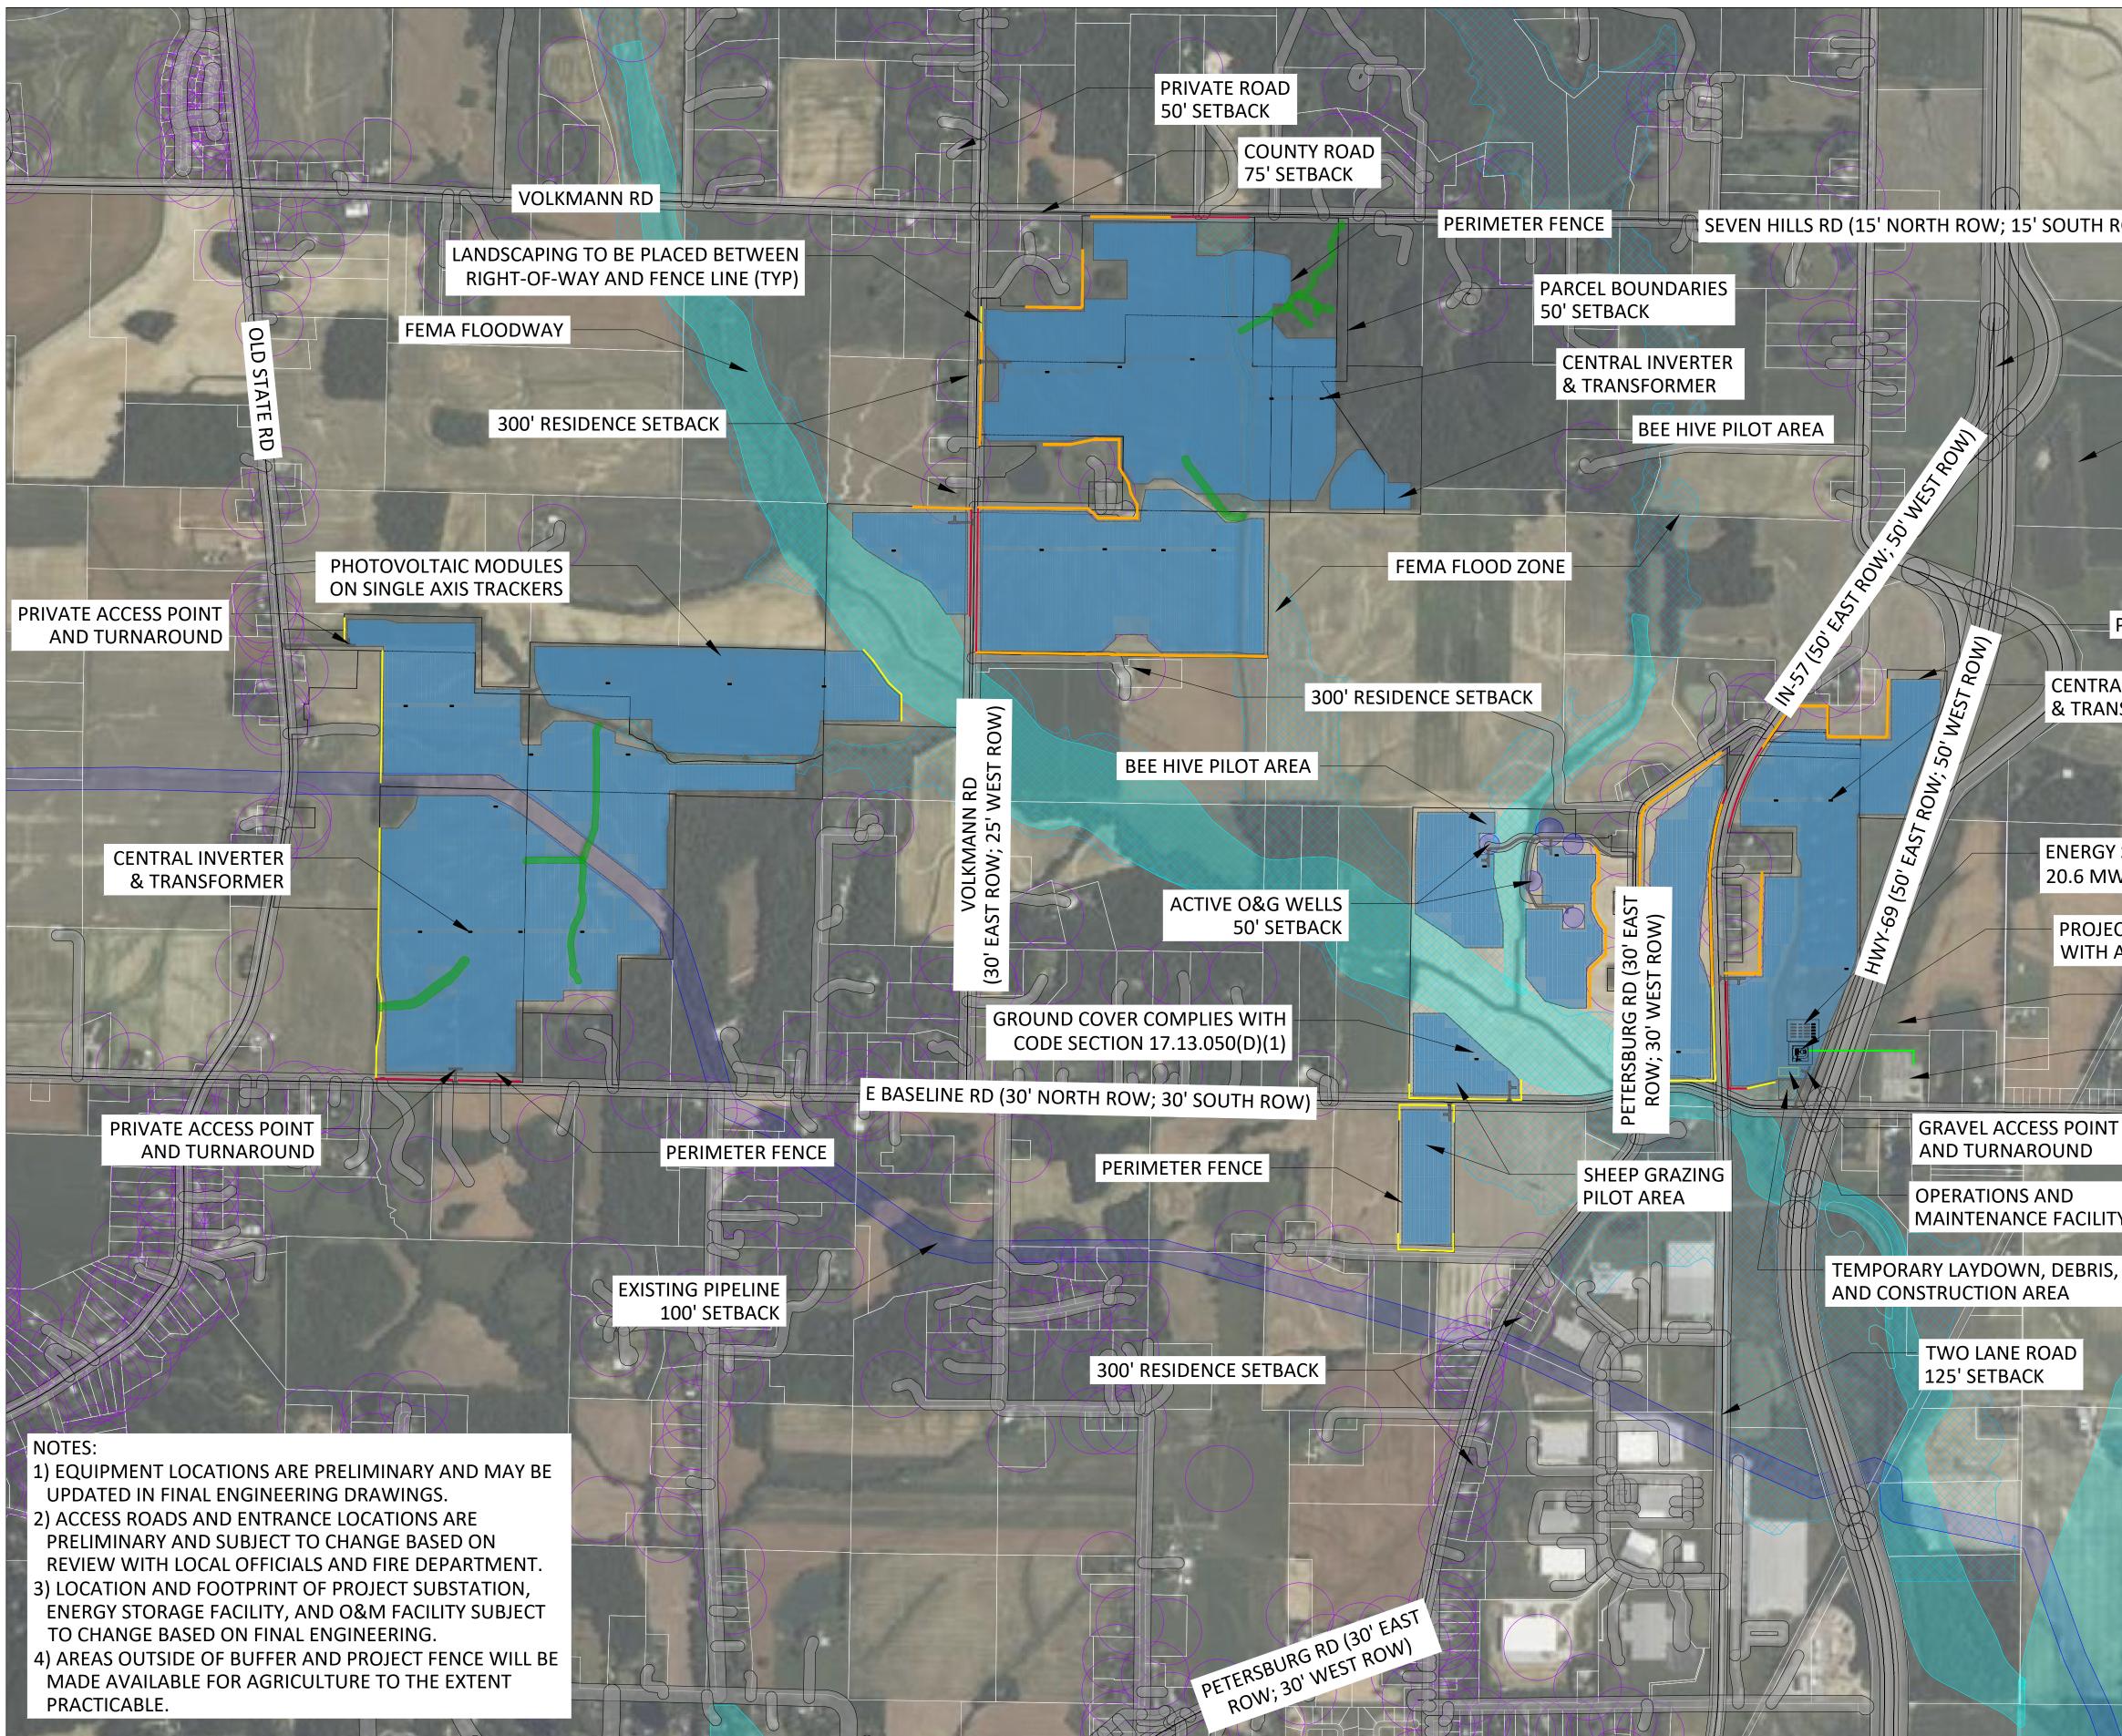


ROW) FOUR LANE ROAD		REPRODUCTION, C REPRODUCTION, C WRITTEN AUTH PROJECT NUMBER: IN-2	DISCLOSURE, OR USE WITHOU HORIZATION IS STRICTLY FOR 022-XXX	GRO JT SPECI BIDDEN			
125' SETBACK		NC	DT FOR CONSTRUCTION		1	1	
					RE	RE	RE
EXISTIN 130' SE	G TRANSMISSION LINE TBACK	OLAR		DATE	5/27/2025	6/2/2025	6/16/2025
PERIMETER FENCE		BLUEGRASS CREEK SC	VANDERBURGH COUNTY,	REVISION	SITE PLAN - APC REVIEW (V1.1)	UPDATED SITE PLAN ANNOTATIONS, DETAILS (V1.2)	UPDATED SITE PLAN EXCLUSIONS, ANNOTATIONS, DETAILS (V1.3)
			ر ر				
CT SUBSTATION APRON TRANSMISSION LINE		PROJ		[≭] LS	1.1	1.2	1.3
					1.1	1.2	
APRON	ECTION	PROJ LATITUDE LONGITUDE	ECT DETAI 38.122627 -87.475851		1.1	1.2	
APRON TRANSMISSION LINE POINT OF INTERCONN	ECTION	LATITUDE	38.122627		1.1	1.2	
APRON TRANSMISSION LINE POINT OF INTERCONN		LATITUDE	38.122627 -87.475851		1.1	1.2	
APRON TRANSMISSION LINE POINT OF INTERCONN LE	GEND	LATITUDE LONGITUDE INTERCON. VOLTAGE	38.122627 -87.475851 69 KV		1.1	1.2	
APRON TRANSMISSION LINE POINT OF INTERCONN LE		LATITUDE LONGITUDE INTERCON. VOLTAGE LEASED AREA	38.122627 -87.475851 69 KV 878.1 ACRES		1.1	1.2	
APRON TRANSMISSION LINE POINT OF INTERCONN LLE	GEND	LATITUDE LONGITUDE INTERCON. VOLTAGE LEASED AREA FENCED AREA	38.122627 -87.475851 69 KV 878.1 ACRES 604.0 ACRES	LS	1.1	1.2	
APRON TRANSMISSION LINE POINT OF INTERCONN LE	EGEND NEXTRACKER ROW (72 & 48 MODULES)	LATITUDE LONGITUDE INTERCON. VOLTAGE LEASED AREA FENCED AREA FENCE LENGTH WIND LOAD SNOW LOAD	38.122627 -87.475851 69 KV 878.1 ACRES 604.0 ACRES 88,408 LF 105 MPH ASCE 7 15 PSF ASCE 7-10	LS	1.1	1.2	
APRON TRANSMISSION LINE POINT OF INTERCONN LE	EGEND NEXTRACKER ROW (72 & 48 MODULES) CENTRAL INVERTER & TRANSFORMER	LATITUDE LONGITUDE INTERCON. VOLTAGE LEASED AREA FENCED AREA FENCE LENGTH WIND LOAD SNOW LOAD DC CAPACITY	38.122627 -87.475851 69 KV 878.1 ACRES 604.0 ACRES 88,408 LF 105 MPH ASCE 7 15 PSF ASCE 7-10 153,581.4 KW	LS	1.1	1.2	
APRON TRANSMISSION LINE POINT OF INTERCONN LE	EGEND INEXTRACKER ROW (72 & 48 MODULES) CENTRAL INVERTER & TRANSFORMER WILDLIFE FRIENDLY FENCE LANDSCAPE SCREENING - TYPE 1	LATITUDE LONGITUDE INTERCON. VOLTAGE LEASED AREA FENCED AREA FENCE LENGTH WIND LOAD SNOW LOAD DC CAPACITY AC CAPACITY	38.122627 -87.475851 69 KV 878.1 ACRES 604.0 ACRES 88,408 LF 105 MPH ASCE 7 15 PSF ASCE 7-10 153,581.4 KW 100,000.0 KW	LS	1.1	1.2	
APRON TRANSMISSION LINE POINT OF INTERCONN LE	EGEND NEXTRACKER ROW (72 & 48 MODULES) CENTRAL INVERTER & TRANSFORMER WILDLIFE FRIENDLY FENCE	LATITUDE LONGITUDE INTERCON. VOLTAGE INTERCON. VOLTAGE LEASED AREA FENCED AREA FENCE LENGTH WIND LOAD SNOW LOAD DC CAPACITY AC CAPACITY DC:AC RATIO	38.122627 -87.475851 69 KV 878.1 ACRES 604.0 ACRES 88,408 LF 105 MPH ASCE 7 15 PSF ASCE 7-10 153,581.4 KW 100,000.0 KW 1.536	-10 >			
APRON TRANSMISSION LINE POINT OF INTERCONN LE	EGEND INEXTRACKER ROW (72 & 48 MODULES) CENTRAL INVERTER & TRANSFORMER WILDLIFE FRIENDLY FENCE LANDSCAPE SCREENING - TYPE 1	LATITUDE LONGITUDE INTERCON. VOLTAGE LEASED AREA FENCED AREA FENCE LENGTH WIND LOAD SNOW LOAD DC CAPACITY AC CAPACITY	38.122627 -87.475851 69 KV 878.1 ACRES 604.0 ACRES 88,408 LF 105 MPH ASCE 7 15 PSF ASCE 7-10 153,581.4 KW 100,000.0 KW	-10 -2 2 & 48 I			
APRON TRANSMISSION LINE POINT OF INTERCONN LE	EGEND NEXTRACKER ROW (72 & 48 MODULES) CENTRAL INVERTER & TRANSFORMER WILDLIFE FRIENDLY FENCE LANDSCAPE SCREENING - TYPE 1 LANDSCAPE SCREENING - TYPE 2	LATITUDE LONGITUDE INTERCON. VOLTAGE INTERCON. VOLTAGE LEASED AREA FENCED AREA FENCE LENGTH WIND LOAD SNOW LOAD DC CAPACITY AC CAPACITY DC:AC RATIO STRUCTURE	38.122627 -87.475851 69 KV 878.1 ACRES 604.0 ACRES 88,408 LF 105 MPH ASCE 7 15 PSF ASCE 7-10 153,581.4 KW 100,000.0 KW 1.536 NEXTRACKER (72)	-10 -2 2 & 48 I			
APRON TRANSMISSION LINE POINT OF INTERCONN LE	GEND NEXTRACKER ROW (72 & 48 MODULES) CENTRAL INVERTER & TRANSFORMER WILDLIFE FRIENDLY FENCE LANDSCAPE SCREENING - TYPE 1 LANDSCAPE SCREENING - TYPE 2 LANDSCAPE SCREENING - TYPE 2A	LATITUDE LONGITUDE INTERCON. VOLTAGE INTERCON. VOLTAGE LEASED AREA FENCED AREA FENCE LENGTH WIND LOAD SNOW LOAD DC CAPACITY AC CAPACITY DC:AC RATIO STRUCTURE TRACKER ROWS	38.122627 -87.475851 69 KV 878.1 ACRES 604.0 ACRES 88,408 LF 105 MPH ASCE 7 15 PSF ASCE 7-10 153,581.4 KW 100,000.0 KW 1.536 NEXTRACKER (72 (2,989 X 72); (894)	-10 -2 2 & 48 I			
APRON TRANSMISSION LINE POINT OF INTERCONN LE	GEND NEXTRACKER ROW (72 & 48 MODULES) CENTRAL INVERTER & TRANSFORMER WILDLIFE FRIENDLY FENCE LANDSCAPE SCREENING - TYPE 1 LANDSCAPE SCREENING - TYPE 2 LANDSCAPE SCREENING - TYPE 2A ACCESS & PUBLIC ROADS UNDERGROUND MV CIRCUIT ROUTING	LATITUDE LONGITUDE INTERCON. VOLTAGE INTERCON. VOLTAGE LEASED AREA FENCED AREA FENCE LENGTH WIND LOAD SNOW LOAD DC CAPACITY AC CAPACITY DC:AC RATIO STRUCTURE TRACKER ROWS AZIMUTH	38.122627 -87.475851 69 KV 878.1 ACRES 604.0 ACRES 88,408 LF 105 MPH ASCE 7 15 PSF ASCE 7-10 153,581.4 KW 100,000.0 KW 1.536 NEXTRACKER (72) 180 DEGREES	LS -10 -10 2 2 & 48 4 X 48)			
APRON TRANSMISSION LINE POINT OF INTERCONN LE	CENTRACKER ROW (72 & 48 MODULES) CENTRAL INVERTER & TRANSFORMER WILDLIFE FRIENDLY FENCE LANDSCAPE SCREENING - TYPE 1 LANDSCAPE SCREENING - TYPE 2 LANDSCAPE SCREENING - TYPE 2A	LATITUDE LONGITUDE INTERCON. VOLTAGE INTERCON. VOLTAGE LEASED AREA FENCED AREA FENCE LENGTH WIND LOAD SNOW LOAD DC CAPACITY AC CAPACITY DC:AC RATIO STRUCTURE TRACKER ROWS AZIMUTH GCR	38.122627 -87.475851 69 KV 878.1 ACRES 604.0 ACRES 88,408 LF 105 MPH ASCE 7 15 PSF ASCE 7-10 153,581.4 KW 100,000.0 KW 1.536 NEXTRACKER (72 180 DEGREES 40.0%	LS -10 -10 2 2 & 48 4 X 48)			
APRON TRANSMISSION LINE POINT OF INTERCONN LEE	GEND NEXTRACKER ROW (72 & 48 MODULES) CENTRAL INVERTER & TRANSFORMER WILDLIFE FRIENDLY FENCE LANDSCAPE SCREENING - TYPE 1 LANDSCAPE SCREENING - TYPE 2 LANDSCAPE SCREENING - TYPE 2A ACCESS & PUBLIC ROADS UNDERGROUND MV CIRCUIT ROUTING	LATITUDE LONGITUDE INTERCON. VOLTAGE INTERCON. VOLTAGE LEASED AREA FENCED AREA FENCE LENGTH WIND LOAD SNOW LOAD DC CAPACITY AC CAPACITY DC:AC RATIO DC:AC RATIO STRUCTURE TRACKER ROWS AZIMUTH GCR MODULE	38.122627 -87.475851 69 KV 878.1 ACRES 604.0 ACRES 88,408 LF 105 MPH ASCE 7 15 PSF ASCE 7-10 153,581.4 KW 100,000.0 KW 1.536 NEXTRACKER (72 (2,989 X 72); (894) 180 DEGREES 40.0% Q.PEAK DUO XL-4	LS -10 -10 2 2 & 48 4 X 48)			
APRON TRANSMISSION LINE POINT OF INTERCONN LEE	GEND NEXTRACKER ROW (72 & 48 MODULES) CENTRAL INVERTER & TRANSFORMER WILDLIFE FRIENDLY FENCE LANDSCAPE SCREENING - TYPE 1 LANDSCAPE SCREENING - TYPE 2 LANDSCAPE SCREENING - TYPE 2A ACCESS & PUBLIC ROADS UNDERGROUND MV CIRCUIT ROUTING FEMA FLOOD ZONE	LATITUDE LONGITUDE INTERCON. VOLTAGE INTERCON. VOLTAGE LEASED AREA FENCED AREA FENCE LENGTH WIND LOAD SNOW LOAD DC CAPACITY AC CAPACITY DC:AC RATIO STRUCTURE TRACKER ROWS AZIMUTH GCR MODULE MODULE CAPACITY	38.122627 -87.475851 69 KV 878.1 ACRES 604.0 ACRES 88,408 LF 105 MPH ASCE 7 15 PSF ASCE 7-10 153,581.4 KW 100,000.0 KW 1.536 NEXTRACKER (72 (2,989 X 72); (894) 180 DEGREES 40.0% S95W	LS -10 -10 2 2 & 48 4 X 48)			
APRON TRANSMISSION LINE POINT OF INTERCONN LE	GEND NEXTRACKER ROW (72 & 48 MODULES) CENTRAL INVERTER & TRANSFORMER WILDLIFE FRIENDLY FENCE LANDSCAPE SCREENING - TYPE 1 LANDSCAPE SCREENING - TYPE 2 LANDSCAPE SCREENING - TYPE 2A ACCESS & PUBLIC ROADS UNDERGROUND MV CIRCUIT ROUTING FEMA FLOOD ZONE FEMA FLOODWAY	LATITUDE LONGITUDE INTERCON. VOLTAGE INTERCON. VOLTAGE LEASED AREA FENCED AREA FENCE LENGTH WIND LOAD SNOW LOAD DC CAPACITY AC CAPACITY DC:AC RATIO STRUCTURE TRACKER ROWS AZIMUTH GCR MODULE MODULE CAPACITY MODULE QUANTITY	38.122627 -87.475851 69 KV 878.1 ACRES 604.0 ACRES 88,408 LF 105 MPH ASCE 7 15 PSF ASCE 7-10 153,581.4 KW 100,000.0 KW 1.536 NEXTRACKER (72 (2,989 X 72); (89 180 DEGREES 40.0% 2,959W 258,120	LS -10 -10) 2 & 48 4 X 48) G11		5/ROV	

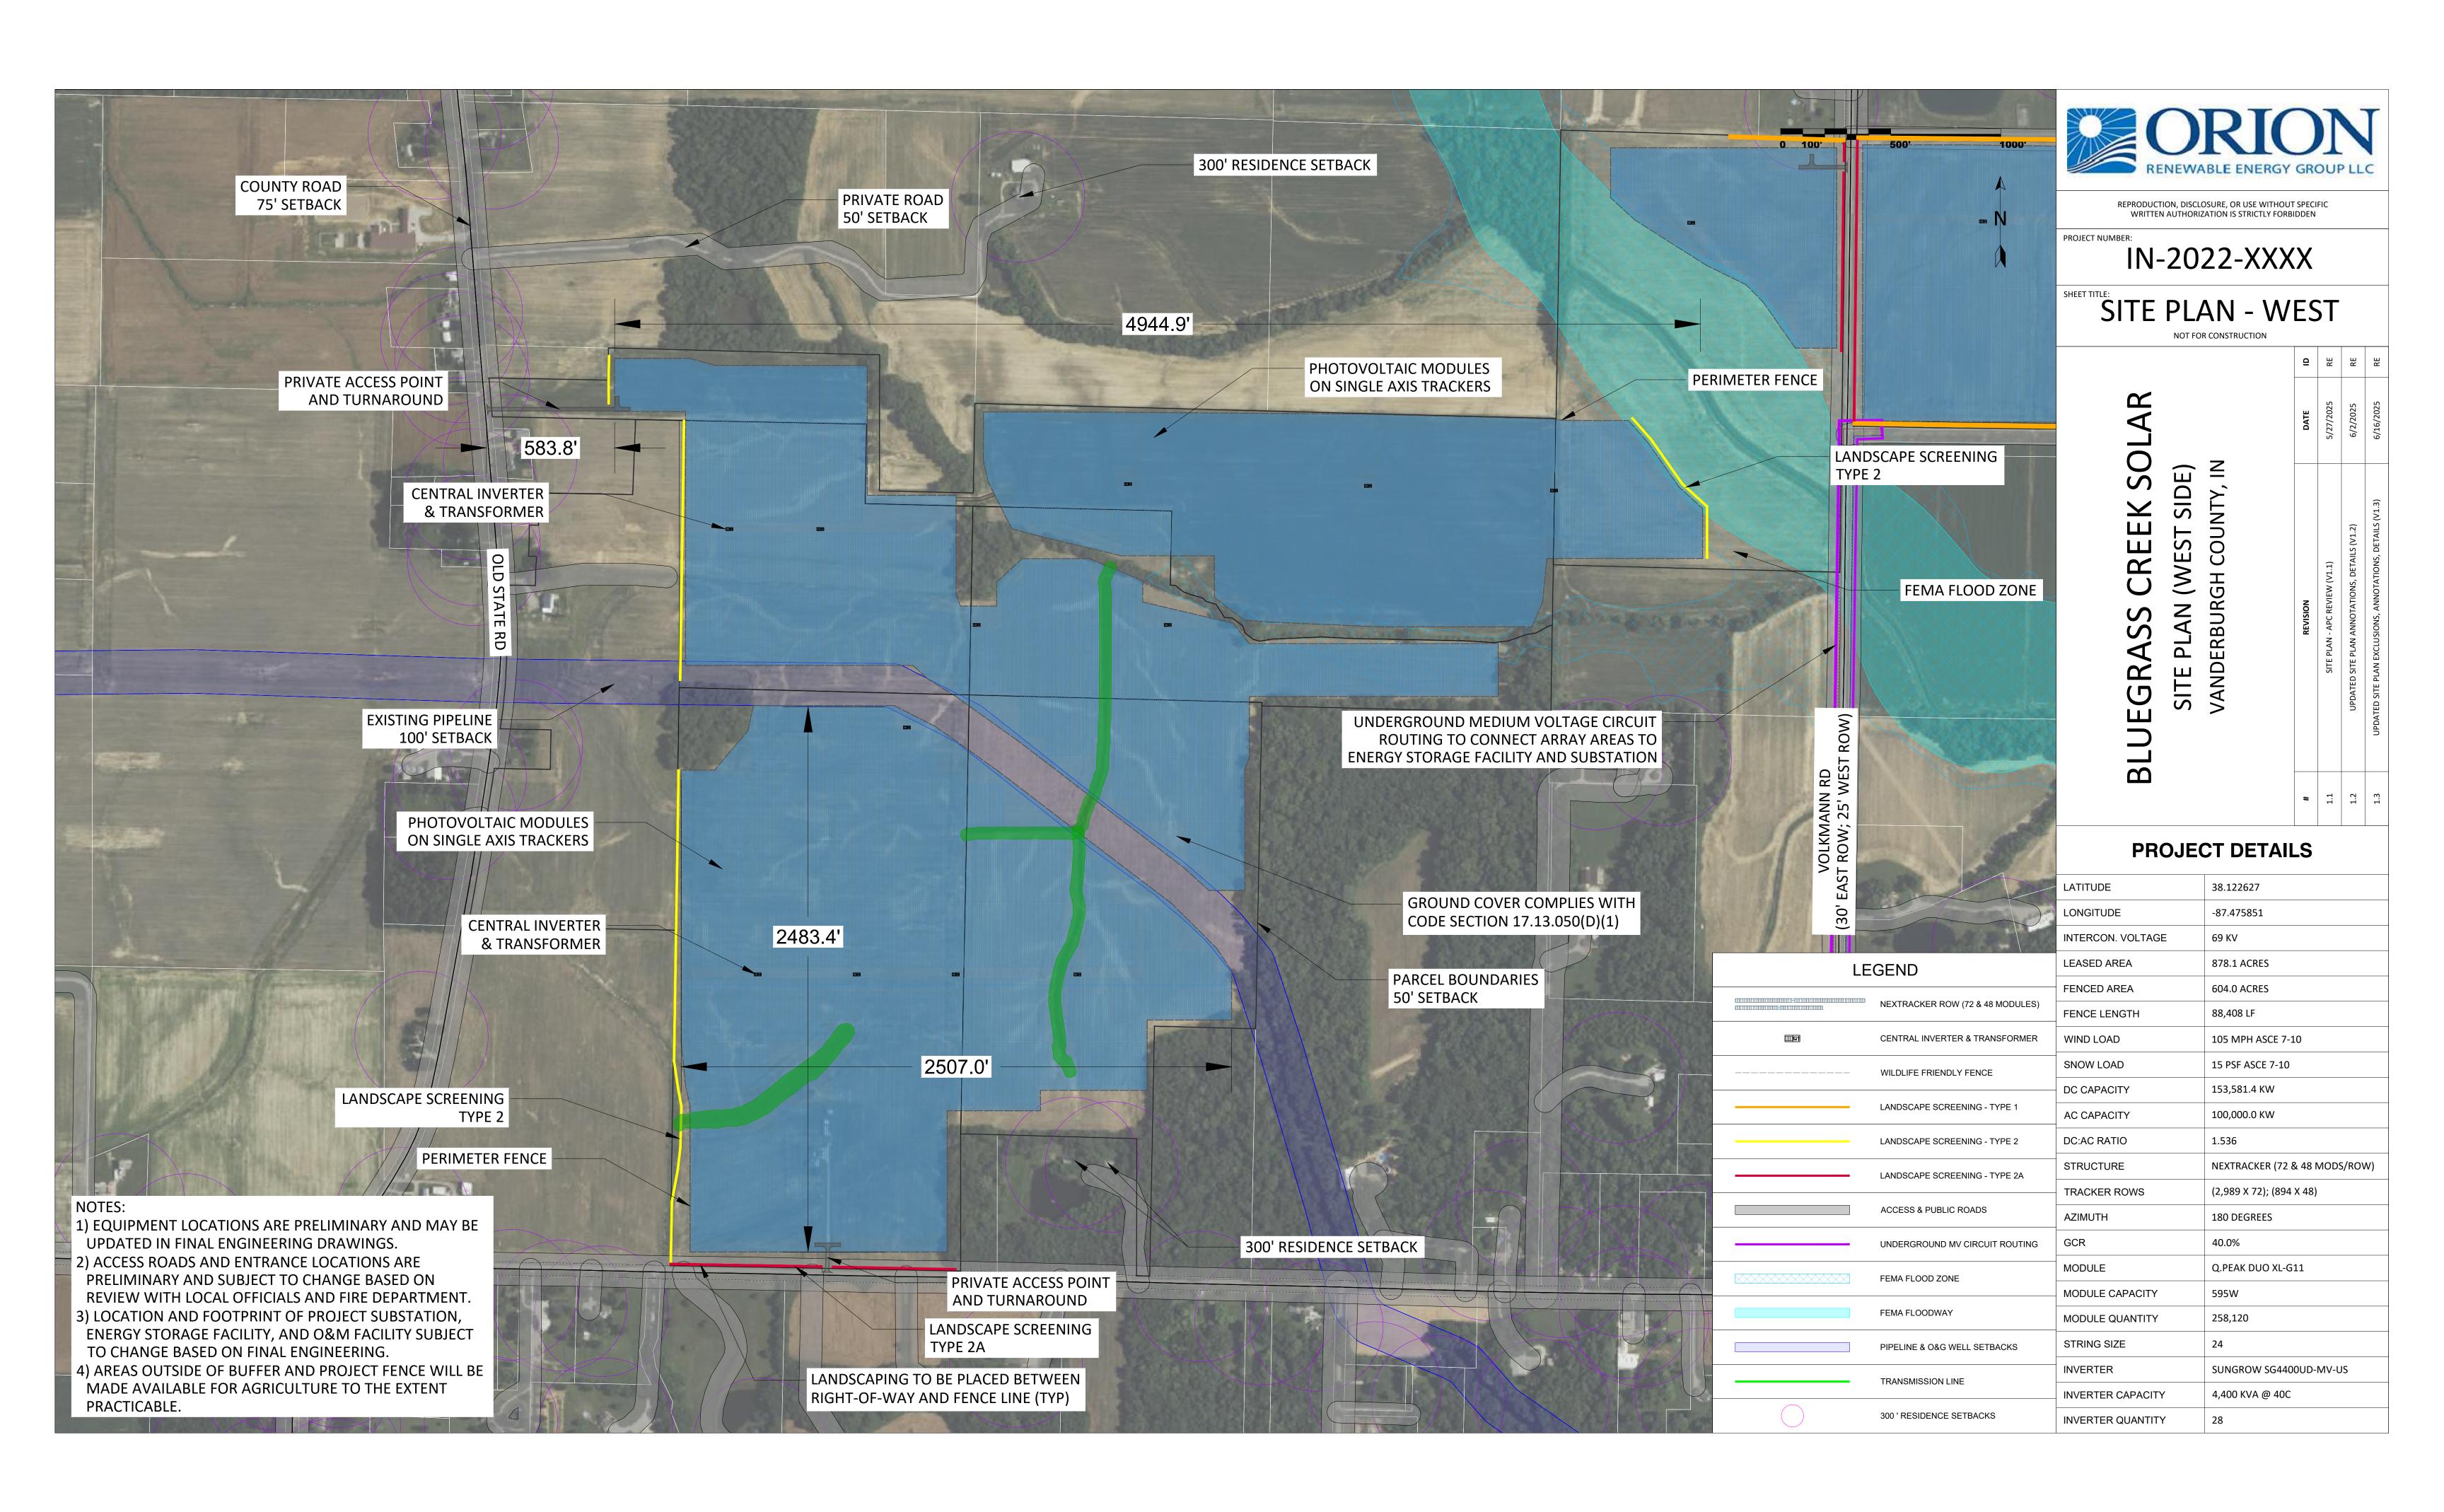


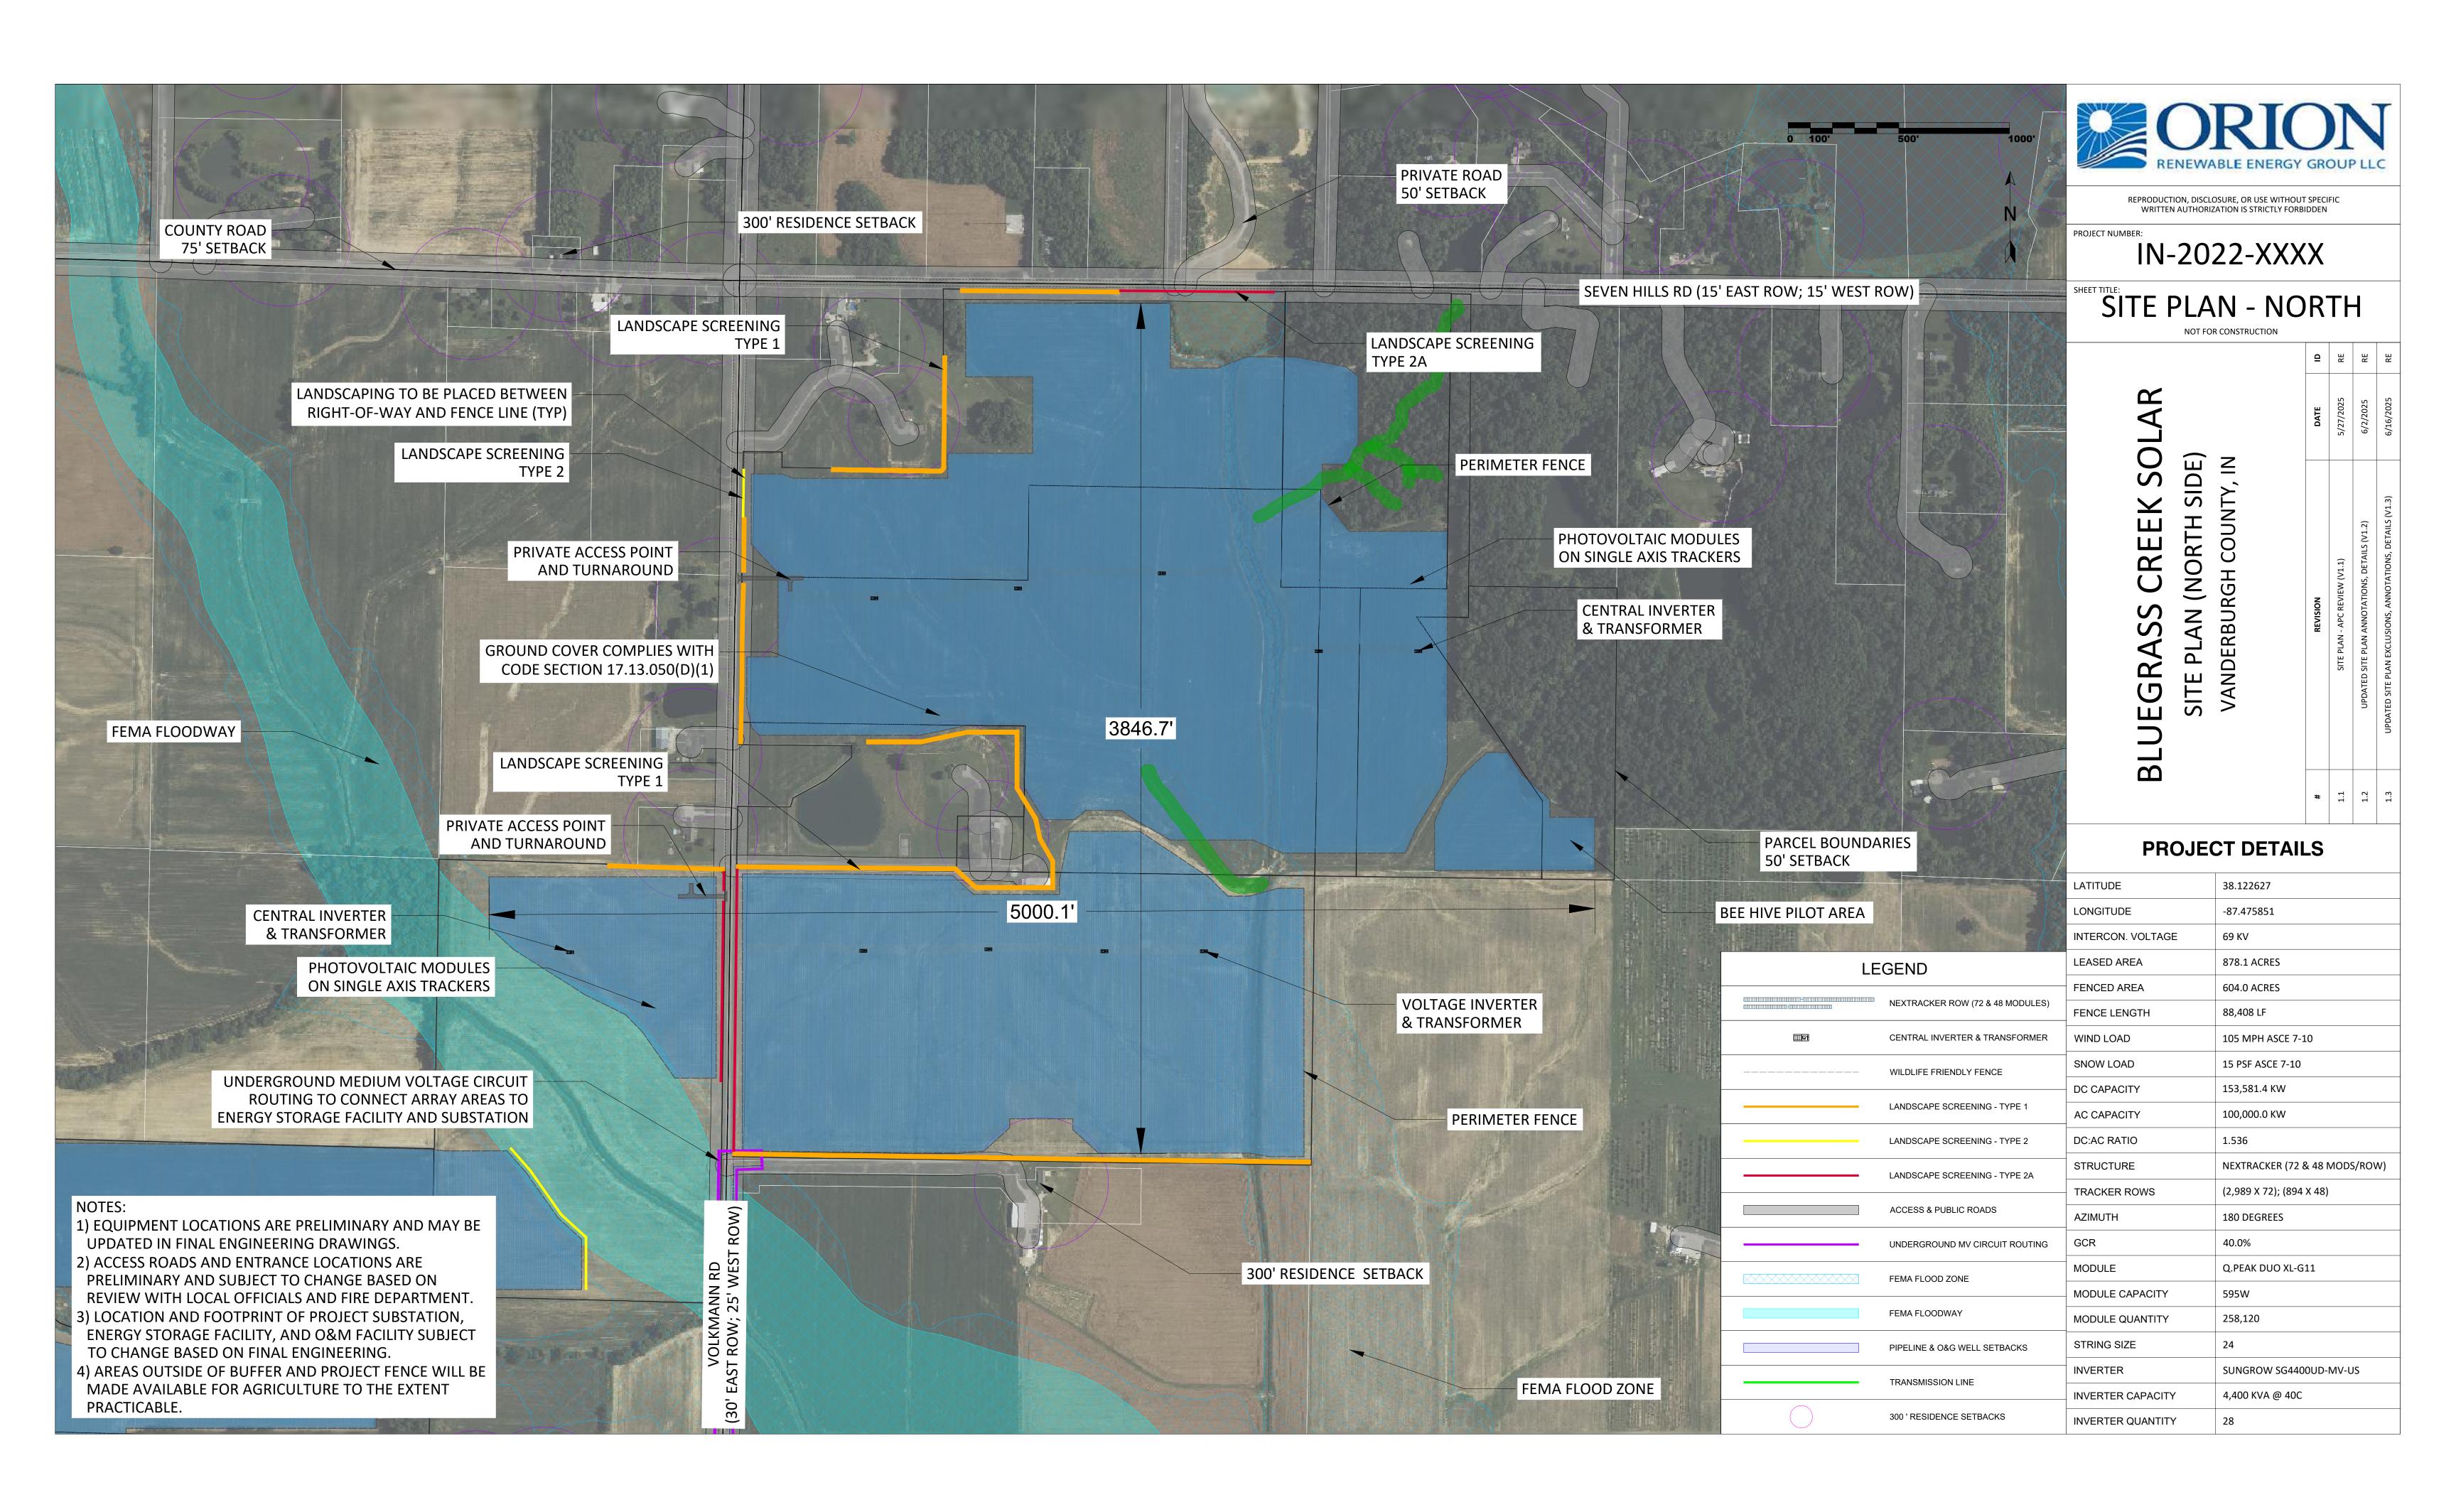

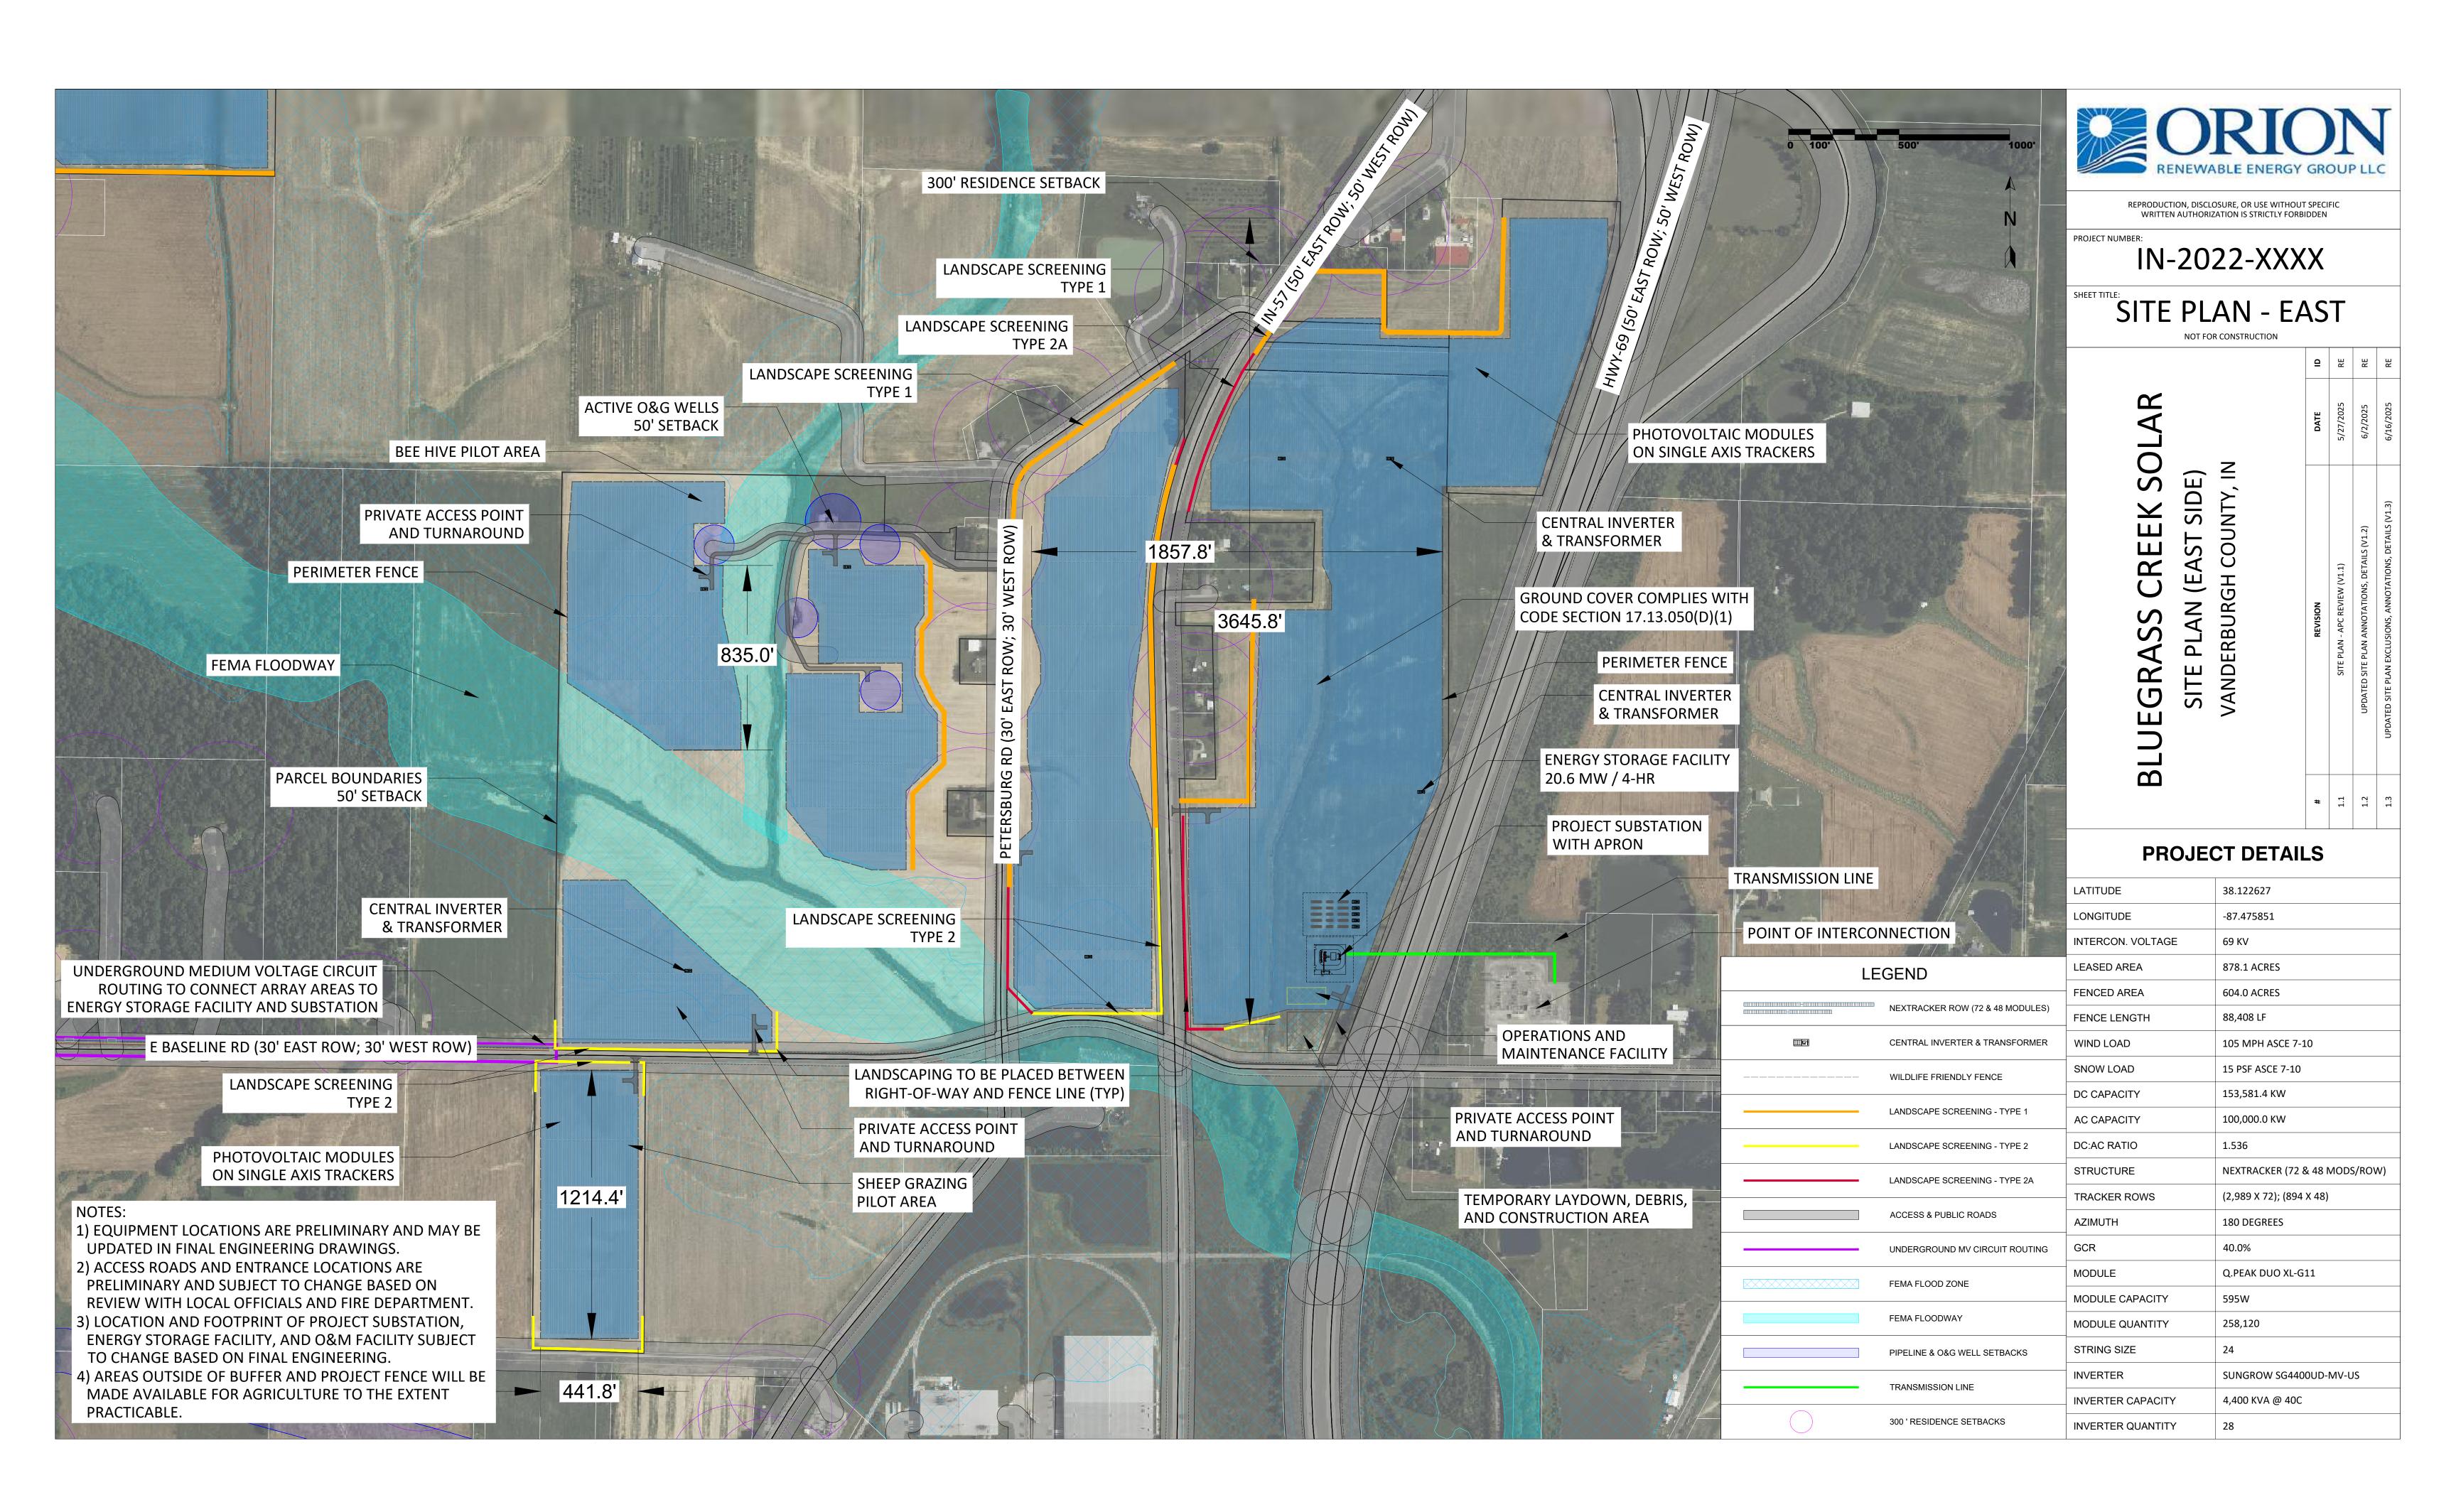


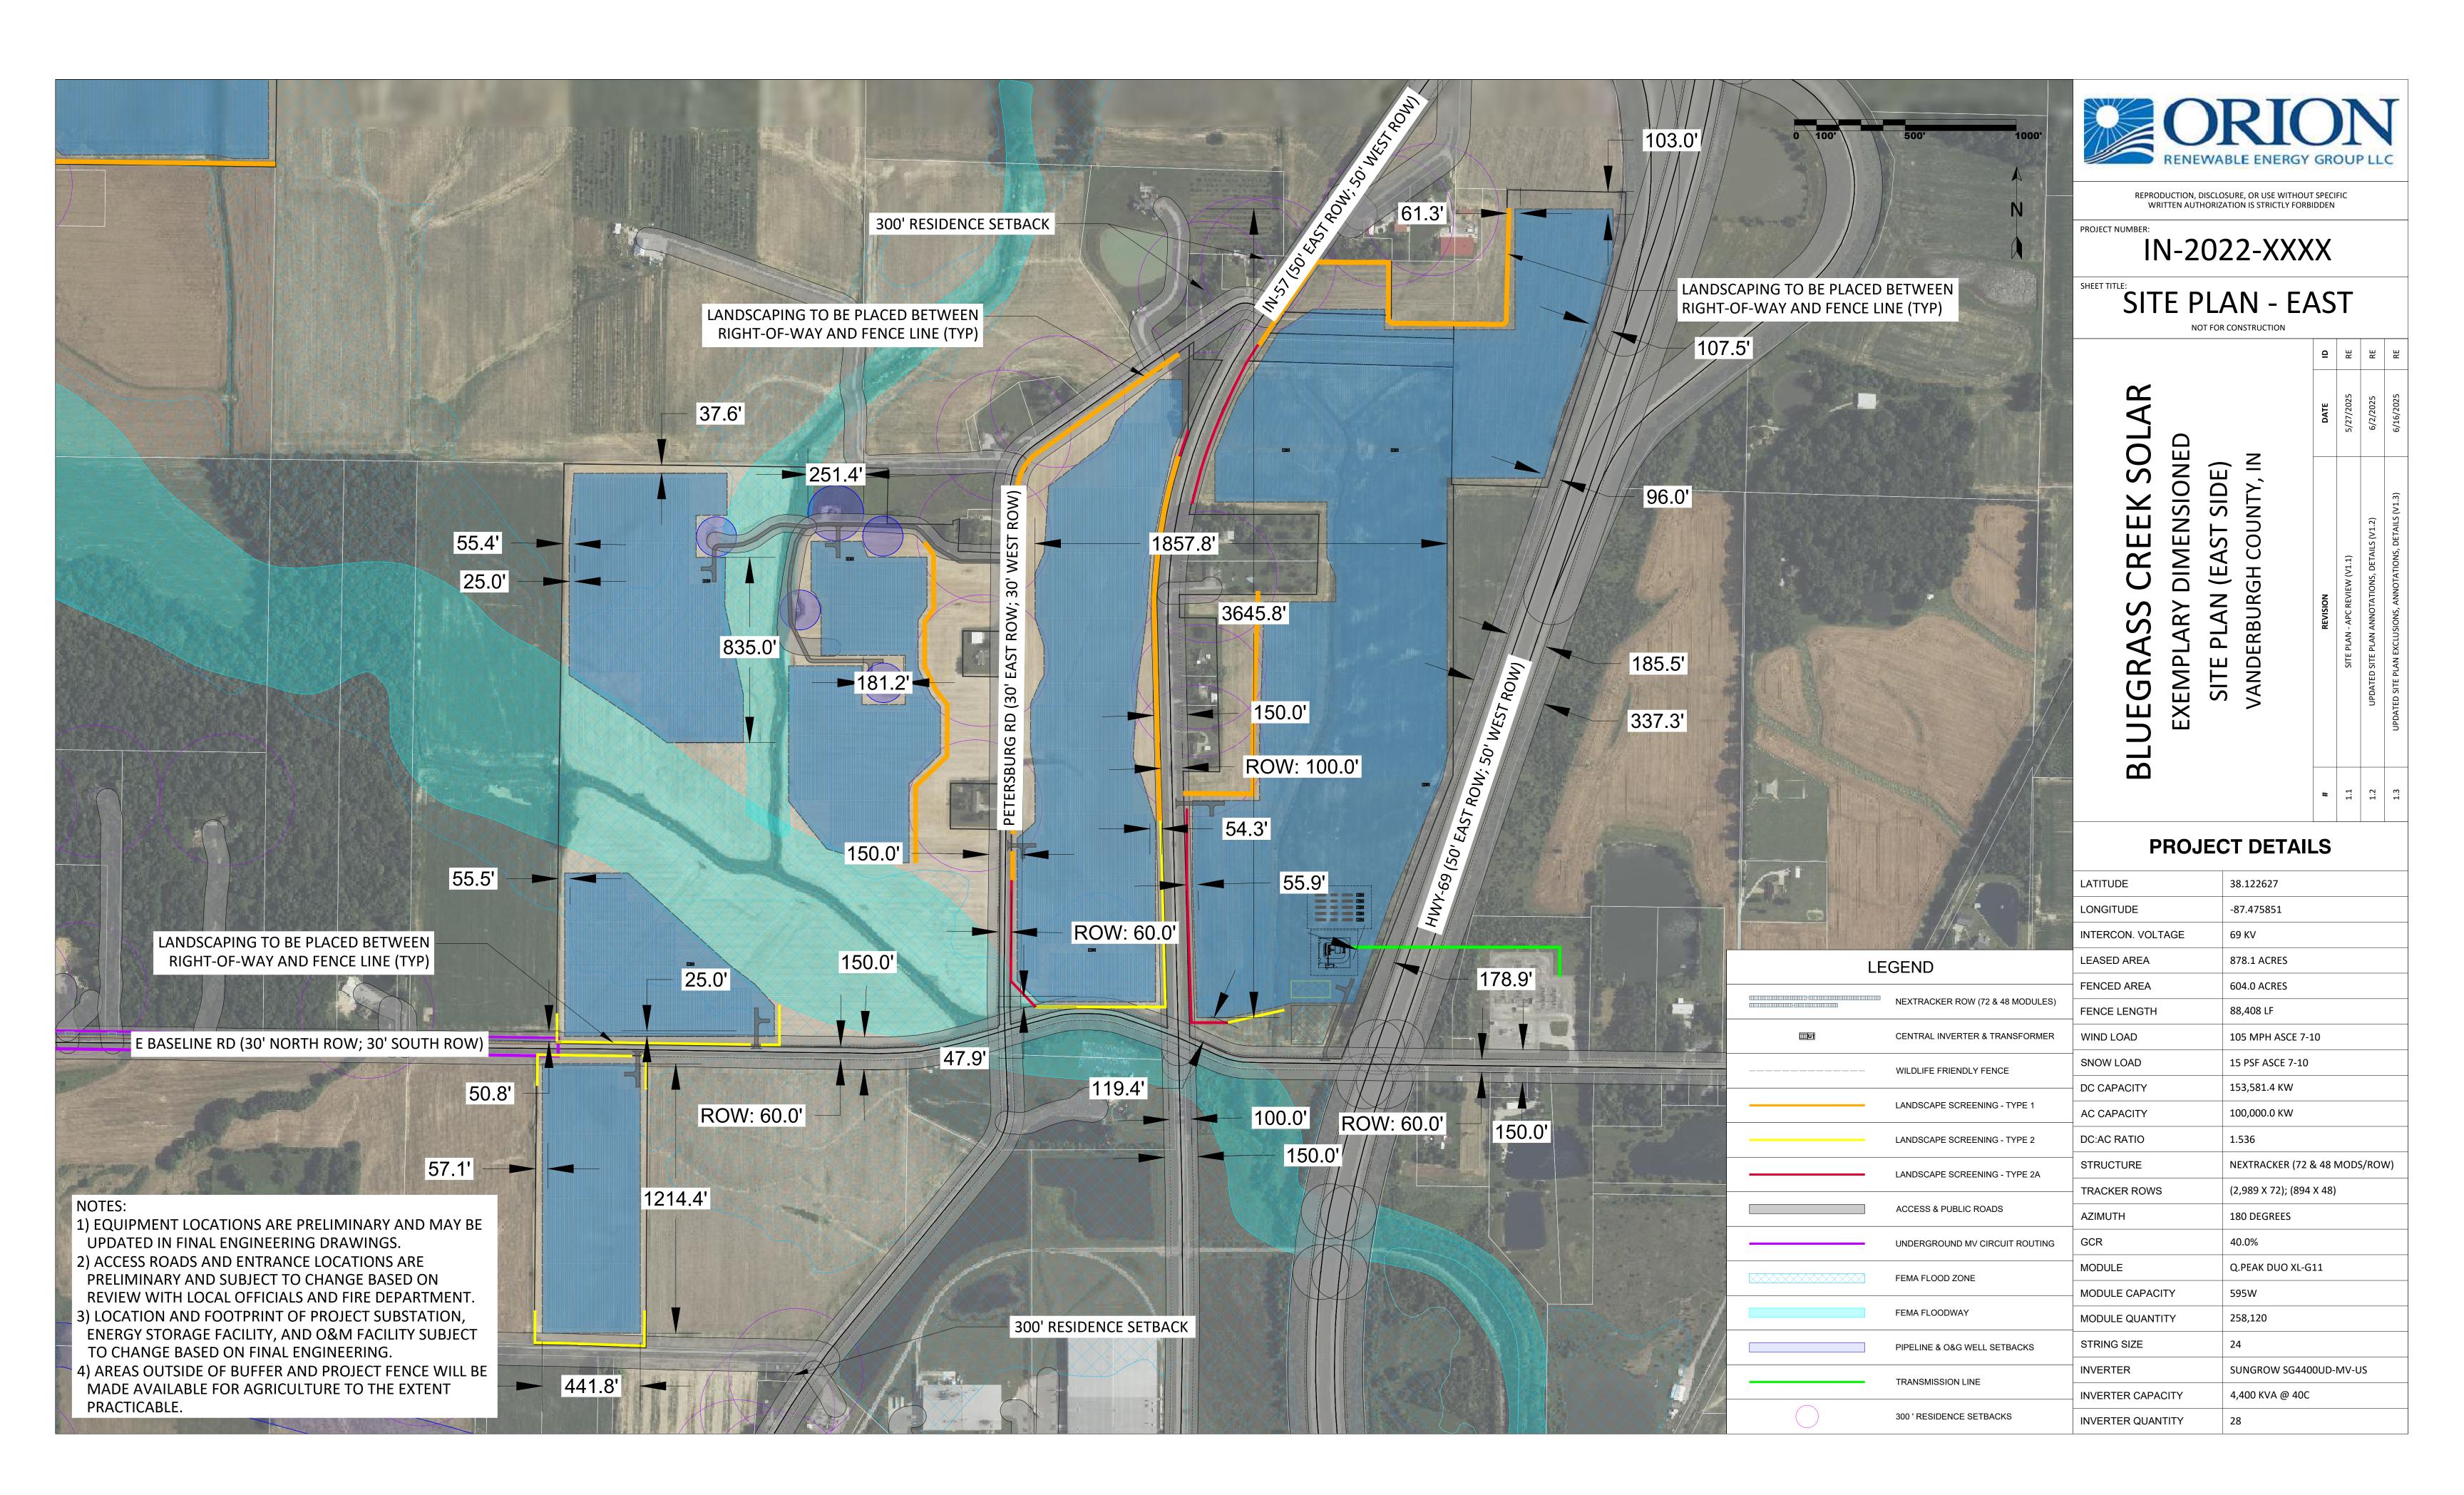

PERIMETER FENCING AND PRIVATE ACCESS ROAD DETAIL

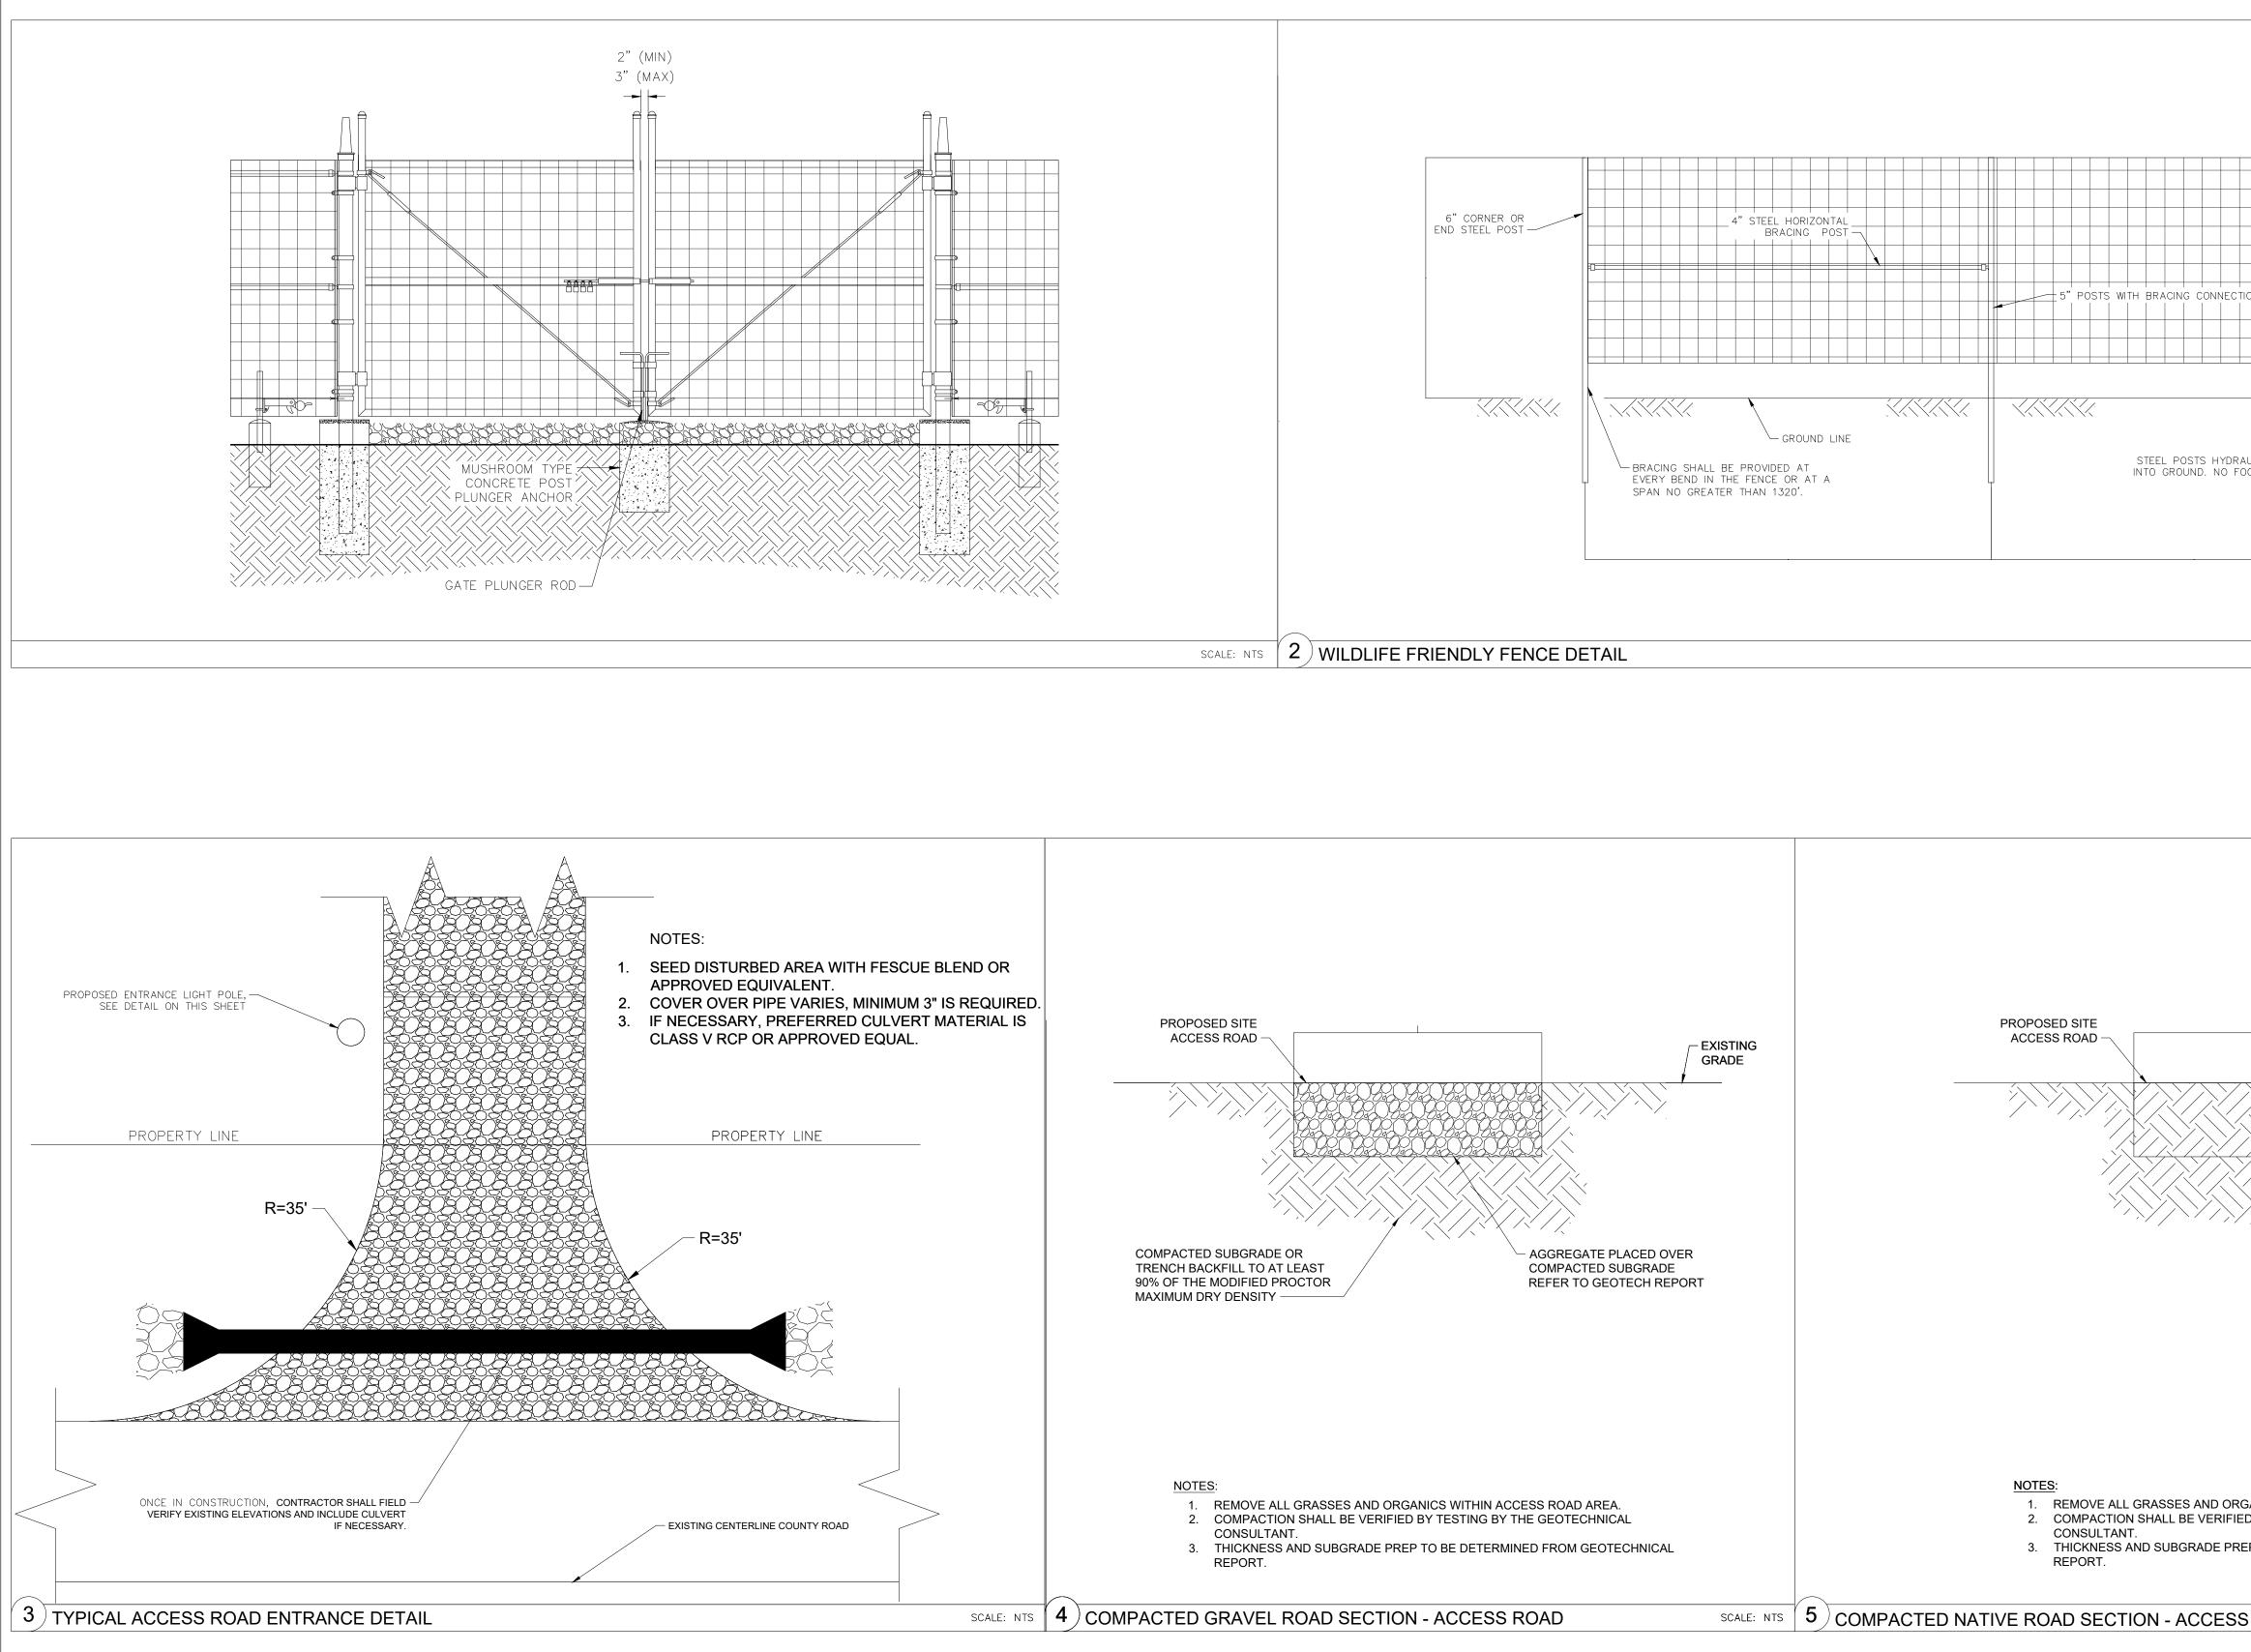

LS			ORIC ENEWABLE ENERG				1 H 1
			TION, DISCLOSURE, OR USE WITH N AUTHORIZATION IS STRICTLY FC				
		PROJECT NUMBER:	-2022-XX	XX			
		SHEET TITLE:					
TOP OF FENC	<u>E</u>		DETAILS NOT FOR CONSTRUCTION				
4" STEEL LINE POSTS				9	RE	RE	RE
FRIENDLY FABRIC				DATE	5/27/2025	6/2/2025	6/16/2025
					5/2	(9)	6/1
AULICALLY DRIVEN OOTING REQUIRED.							
OOTING REQUIRED							
			ILS				
			AND ACCESS ROAD DETAI URGH COUNTY, IN				
	SCALE: NTS	AR	D D				
		OL	N N				
		GRASS CREEK SOLAR	FENCING AND ACCESS RC VANDERBURGH COUNTY, IN				
			NCCE OUN			V1.2)	TAILS (V1.3)
		CR			(V1.1)	, DETAILS (ATIONS, DE
		SS	BUR	REVISION	SITE PLAN - APC REVIEW (V1.1)	UPDATED SITE PLAN ANNOTATIONS, DETAILS (V1.2)	UPDATED SITE PLAN EXCLUSIONS, ANNOTATIONS, DETAILS (V1.3)
		RA	CINC	REV	'E PLAN - AF	E PLAN AN	I EXCLUSION
EXISTING GRADE		EG	LAN		SIT	PDATED SIT	D SITE PLAN
		BLUI	\mathbf{x}				UPDATE
		B	PERIMETE				
			ERIN				
CONDITIONED AND RE-COMPACTED TO A MINIMUM			<u>с</u>				
DENSITY OF 90%							
GANICS WITHIN ACCESS ROAD AREA. ED BY TESTING BY THE GEOTECHNICAL							
EP TO BE DETERMINED FROM GEOTECHNICAL							
S ROAD	SCALE: 1"=50'			#	1.1	1.2	1.3

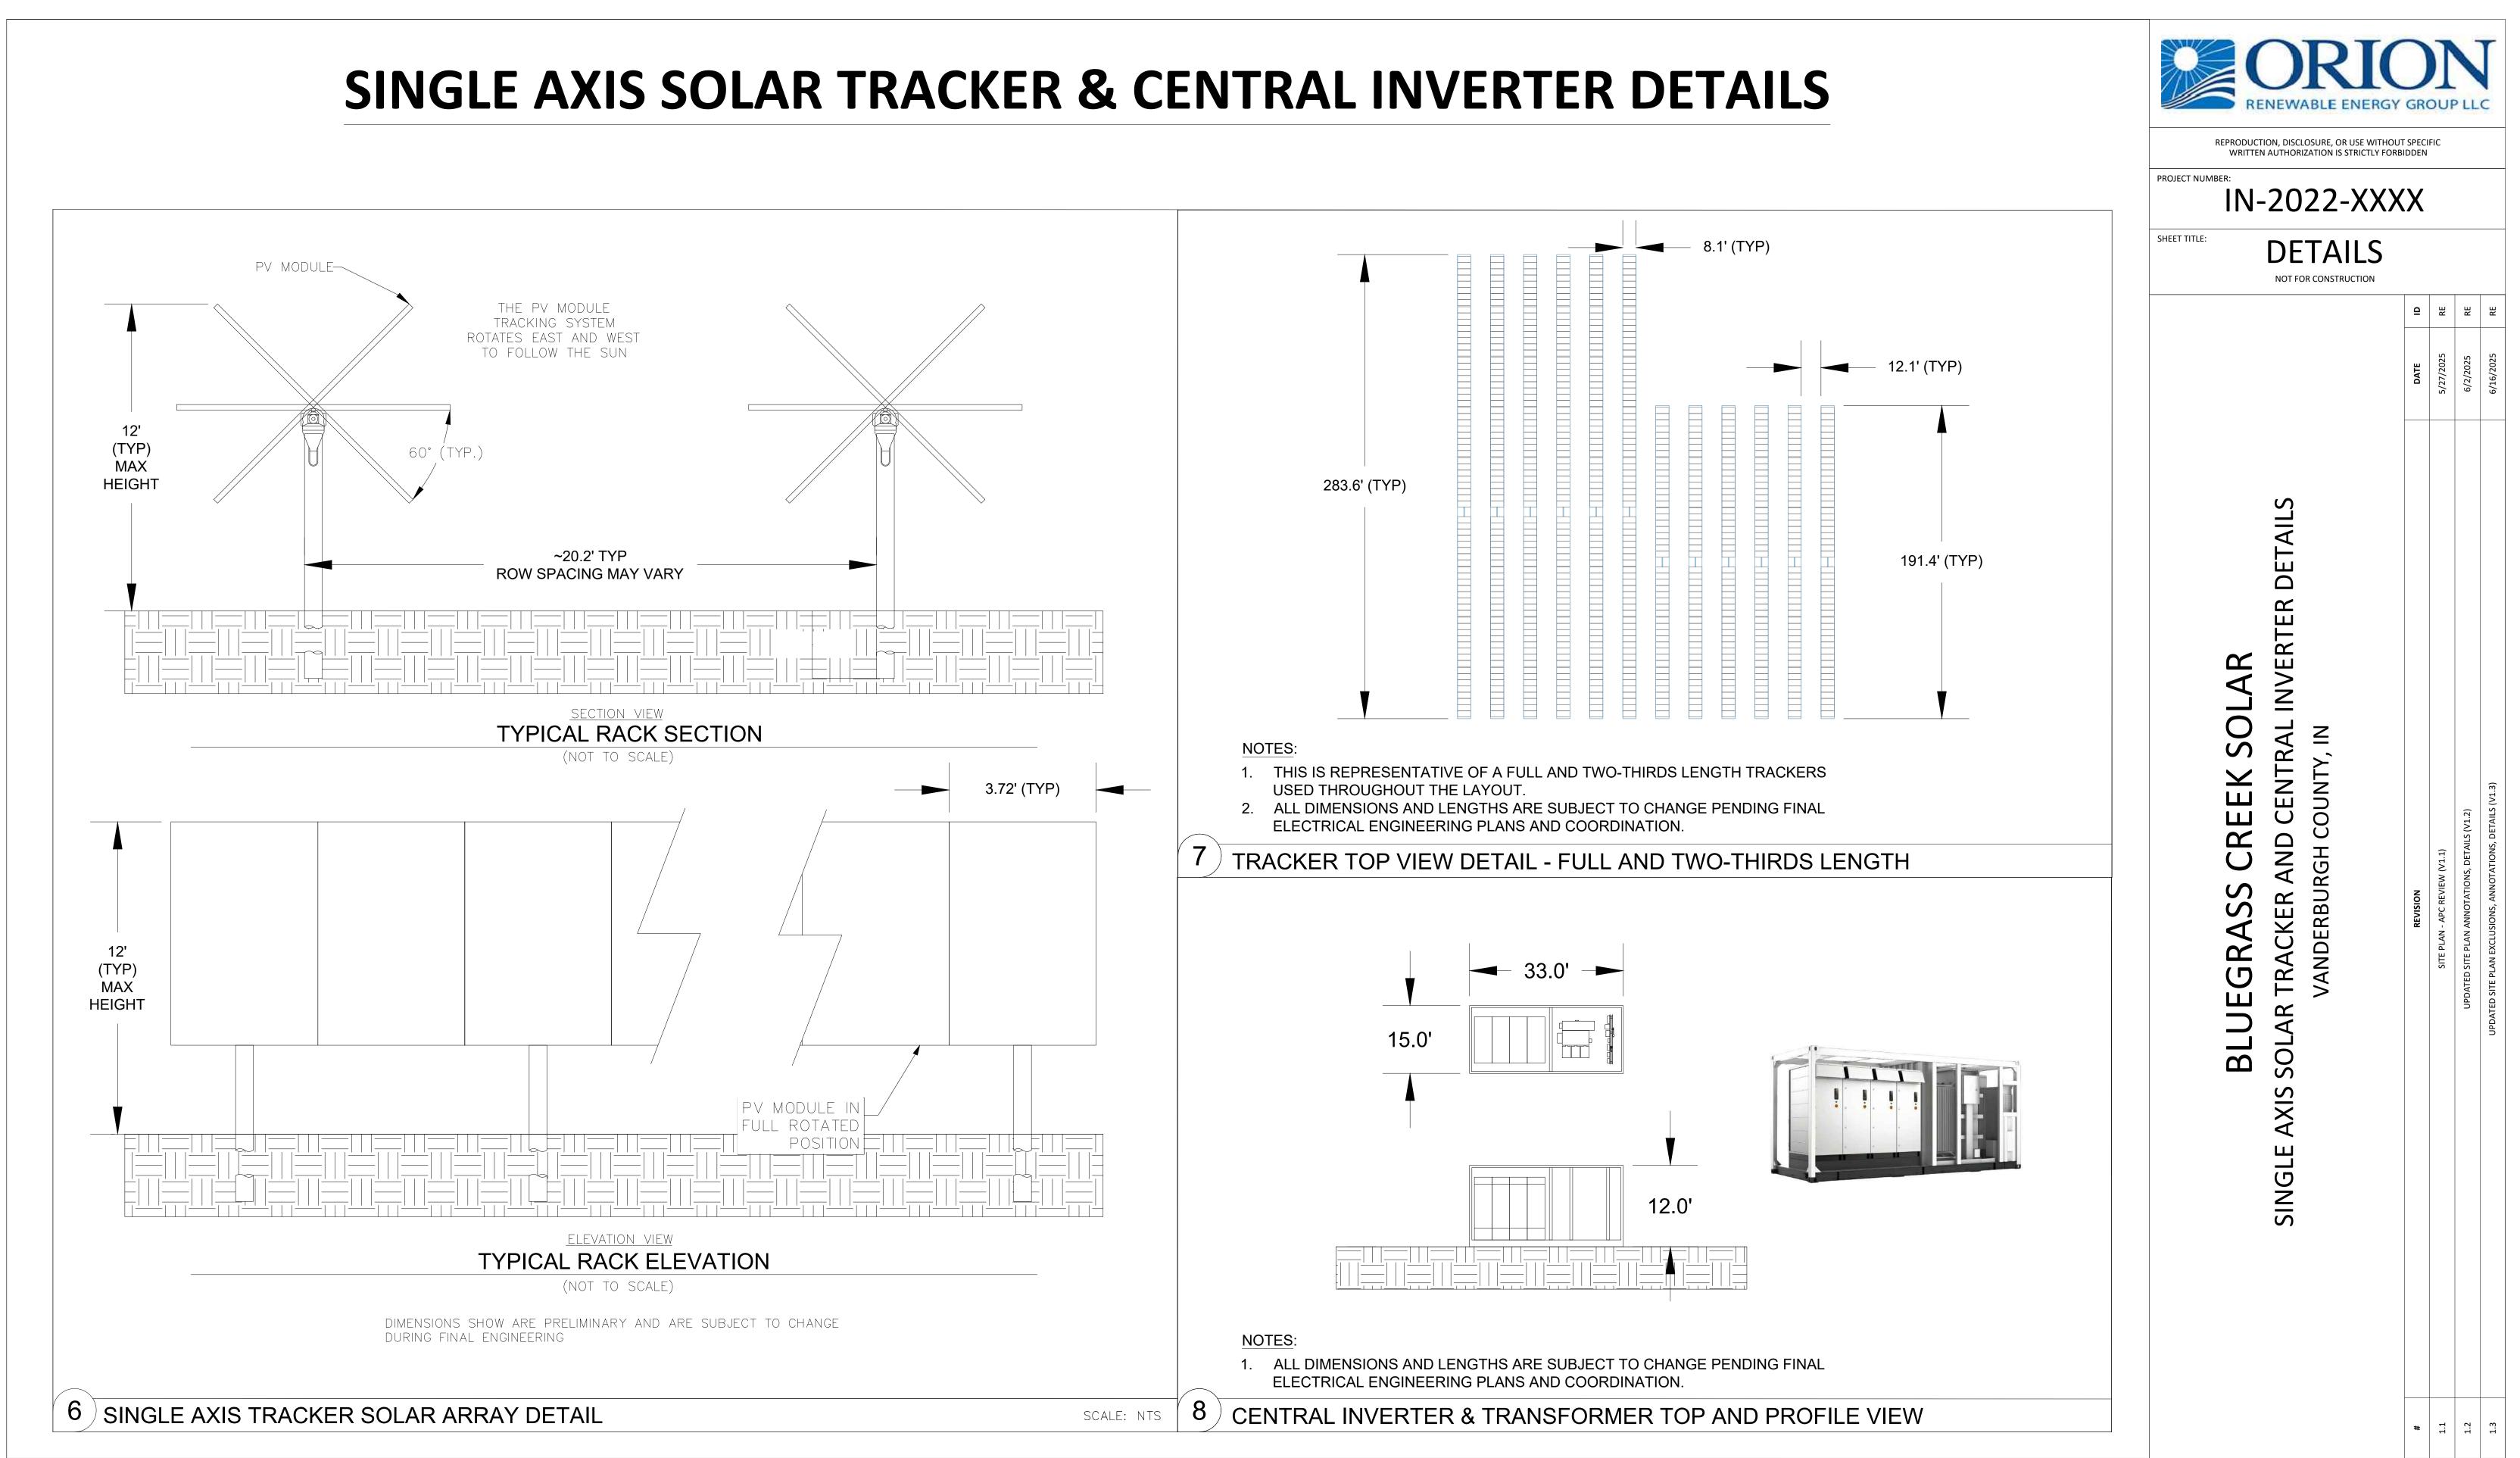

SUBSTATION, FENCING, & MOTION ACTIVATED LIGHTING DETAILS


PUBLIC RIGHT OF WAY WIDTHS			
ROAD NAME	SIDE	ROW WIDTH FROM CENTERLINE	
SEVEN HILLS RD	NORTH	15 FEET	
SEVEN HILLS RD	SOUTH	15 FEET	
SR 57	EAST	50 FEET	
SR 57	WEST	50 FEET	
BASELINE ROAD	NORTH	30 FEET	
BASELINE ROAD	SOUTH	30 FEET	
VOLKMAN ROAD	EAST	30 FEET	
VOLKMAN ROAD	WEST	25 FEET	
OLD PETERSBURG RD	EAST	30 FEET	
OLD PETERSBURG RD	WEST	30 FEET	
INTERSTATE I-69	EAST	50 FEET	
INTERSTATE I-69	WEST	50 FEET	

REQUIRED AND OBSERVED SETBACKS


SETBACK FROM	REQUIRED SETBACK	OBSERVED SETBACK
PUBLIC ROAD ROW	40 FEET	40 TO 100 FEET
NON-PARTICIPATING HOUSES	250 FEET FROM PRINCIPAL RESIDENTIAL STRUCTURE	OVER 300 FEET
NON-PARTICIPATING PROPERTY LINE	50 FEET	50 FEET OR MORE


PUBLIC ROAD ROW	40 FEET	40 TO 100 FEET
NON-PARTICIPATING HOUSES	250 FEET FROM PRINCIPAL RESIDENTIAL STRUCTURE	OVER 300 FEET
NON-PARTICIPATING PROPERTY LINE	50 FEET	50 FEET OR MORE

ROAD NAME	SIDE	ROW WIDTH FROM CENTERLINE
SEVEN HILLS RD	NORTH	NONE
SEVEN HILLS RD	SOUTH	NONE
SR 57	EAST	1,090 FEET NORTH OF BASELINE ON 82-02-36-009-044.024-030, THE MCCUTCHAN LAND TRUST PROPERTY
		(1) NEXT TO I-69 ON 82-02-36-009-044.024-030, MCCUTCHAN LAND TRUST PROPERTY
BASELINE ROAD	NORTH	(2) 1,140 FEET WEST OF OLD PETERSBURG ON 82-02-35-009-044.027-030, WHEELER ENTERPRISES, L.P. PROPERTY
		(3) 4,615 FEET WEST OF VOLKMAN ON 82-02-34-009-040.004-030, ALLEN KALLENBACH AND JACQUELINE KALLENBACH PROPERTY
BASELINE ROAD	SOUTH	1,650 FEET WEST OF OLD PETERSBURG RD ON 82-04-02-009-055.004-030 WHEELER ENTERPRISES, L.P. PROPERTY
VOLKMAN ROAD	EAST	1,345 FEET SOUTH OF SEVEN HILLS ON 82-02-35-009-024.003-030, CURRAN & ANN MILLER FAMILY LLC PROPERTY
VOLKMAN ROAD	WEST	2,810 FEET SOUTH OF SEVEN HILLS ON 82-02-34-009-041.003-030, CURRAN & ANN MILLER FAMILY LLC PROPERTY
OLD PETERSBURG RD	EAST	840 FEET NORTH OF BASELINE RD. ON 82-02-36-009-044.002-030, WHEELER ENTERPRISES, L.P. PROPERTY
OLD PETERSBURG RD	WEST	2,160 FEET NORTH OF BASELINE RD. ON 82-02-35-009-044.027-030, WHEELER ENTERPRISES, L.P. PROPERTY
OLD STATE RD	EAST	4,150 FEET SOUTH OF VOLKMAN ON 82-02-34-009-040.014-030, DARWIN P. MARTIN AND GERALDINE K. MARTIN PROPERTY
OLD STATE RD	WEST	NONE

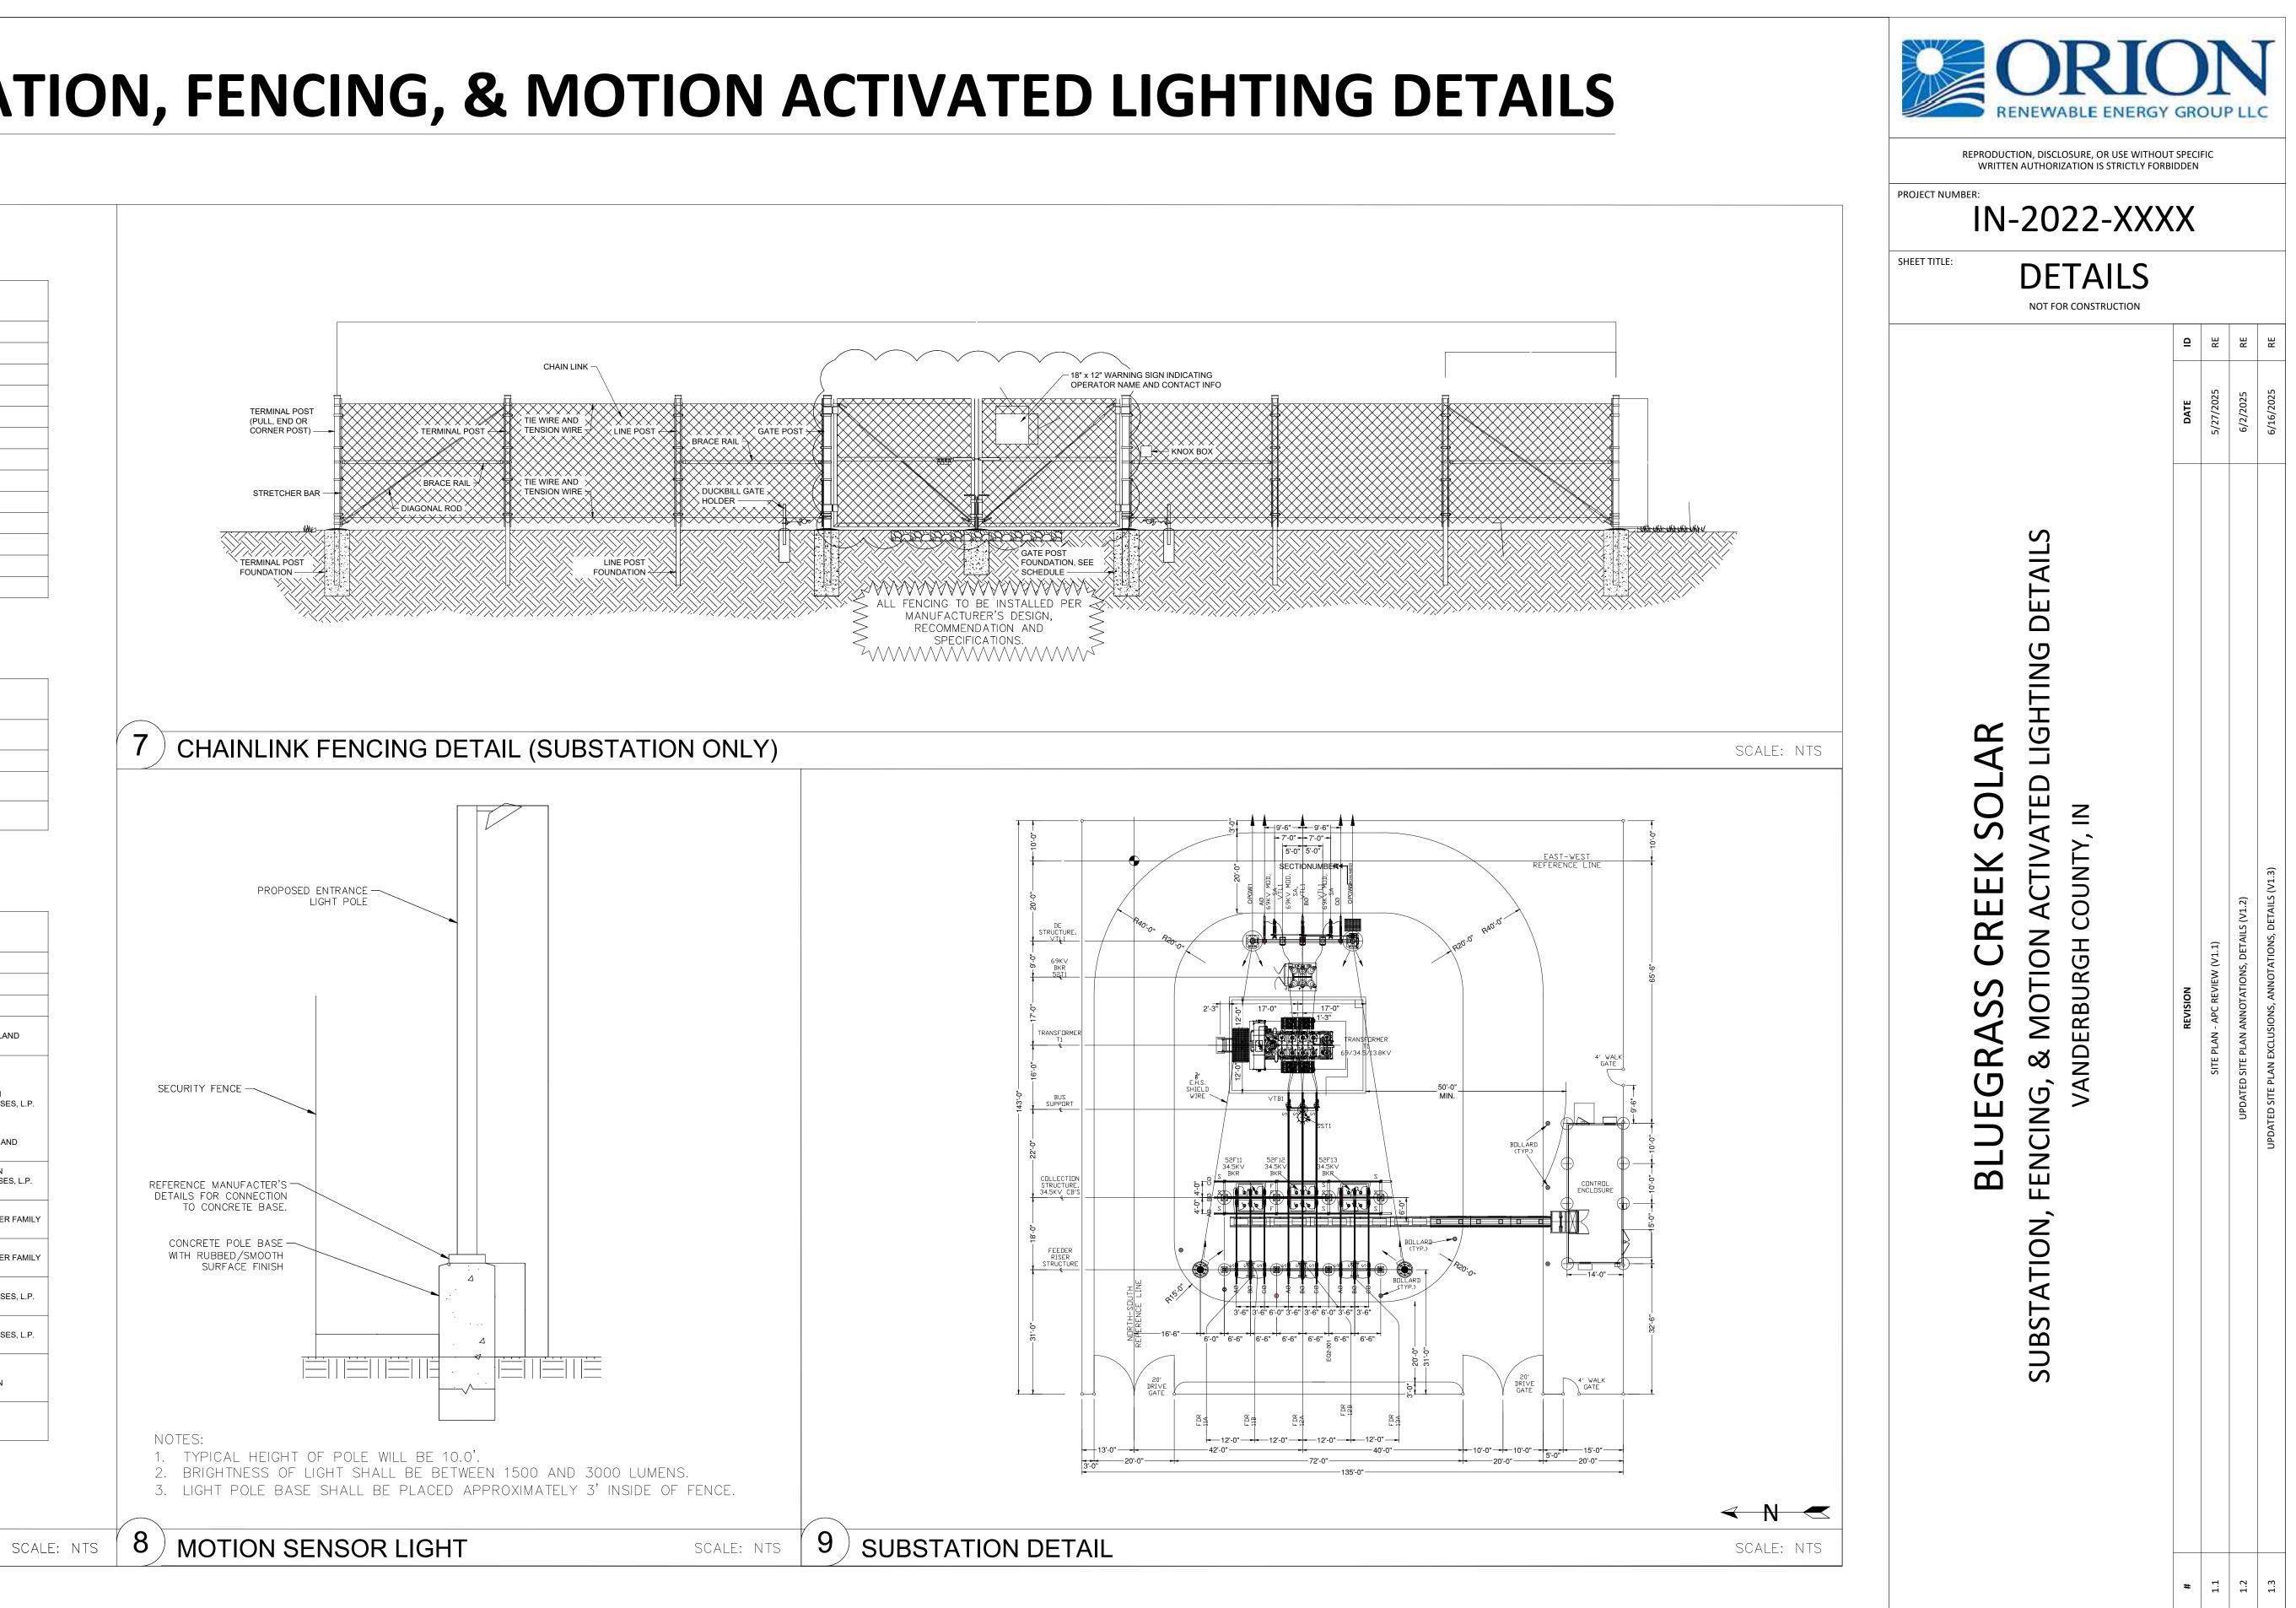


8 ROW, SETBACKS, CURB CUTS

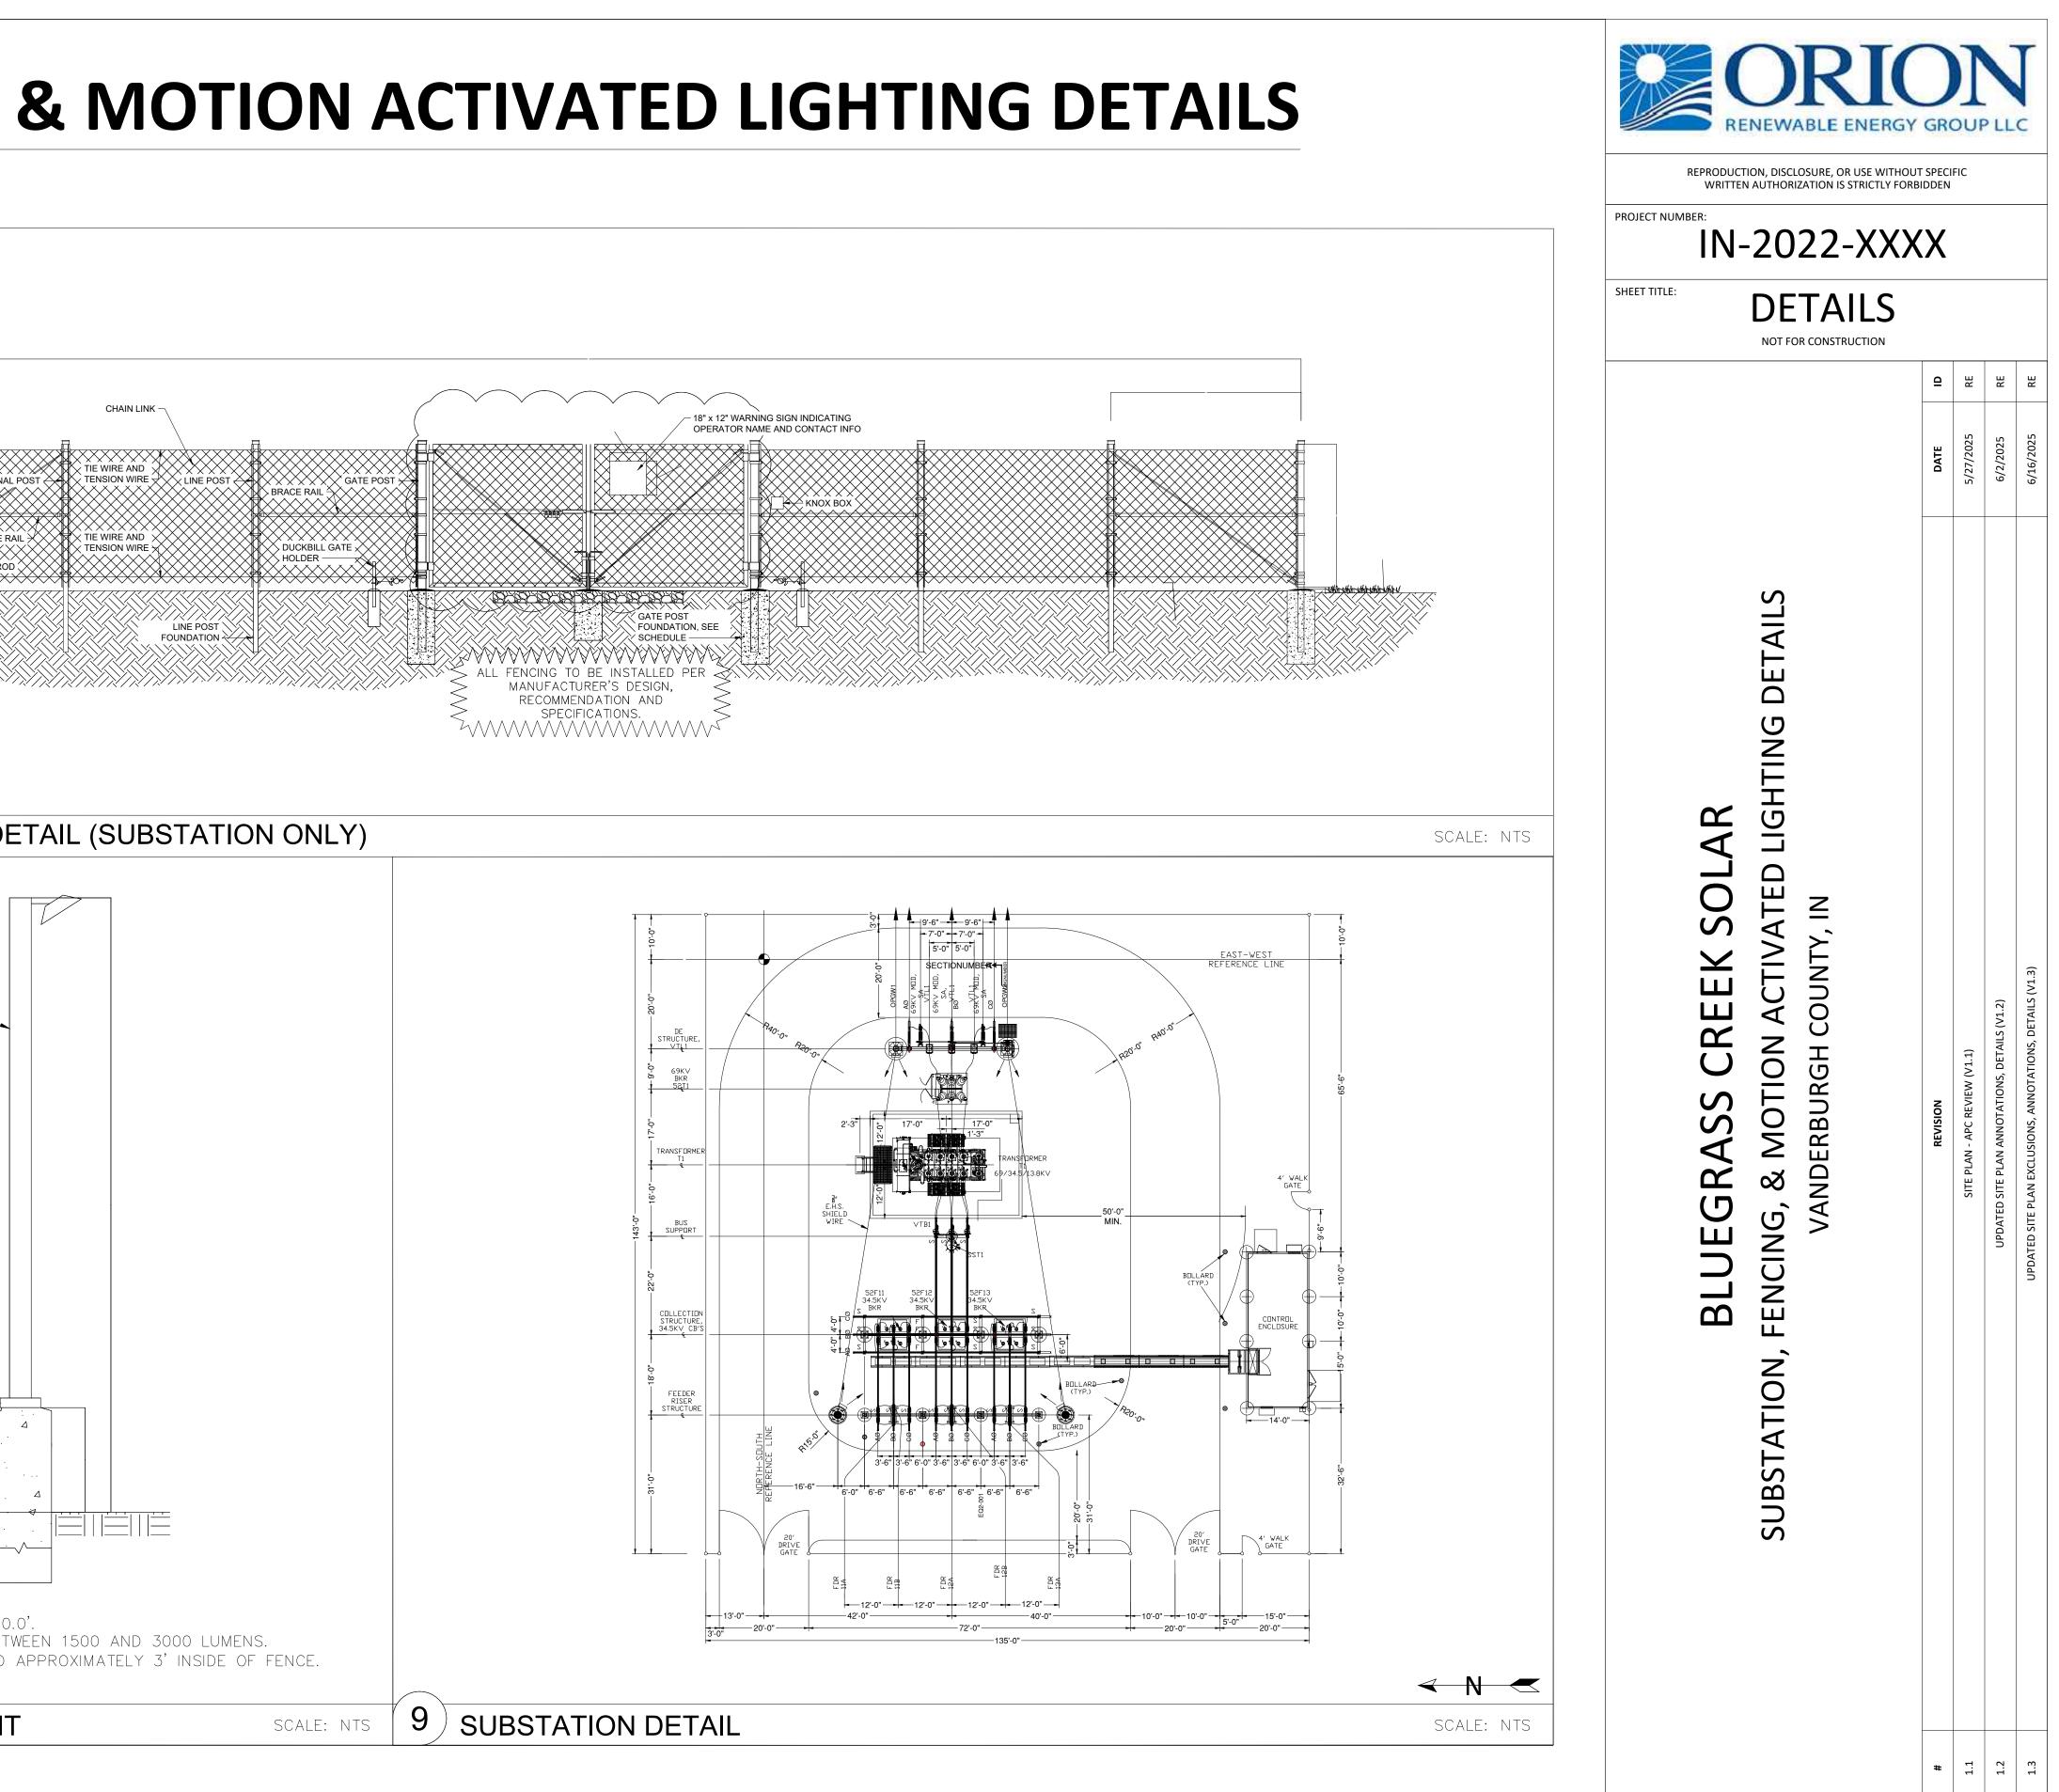

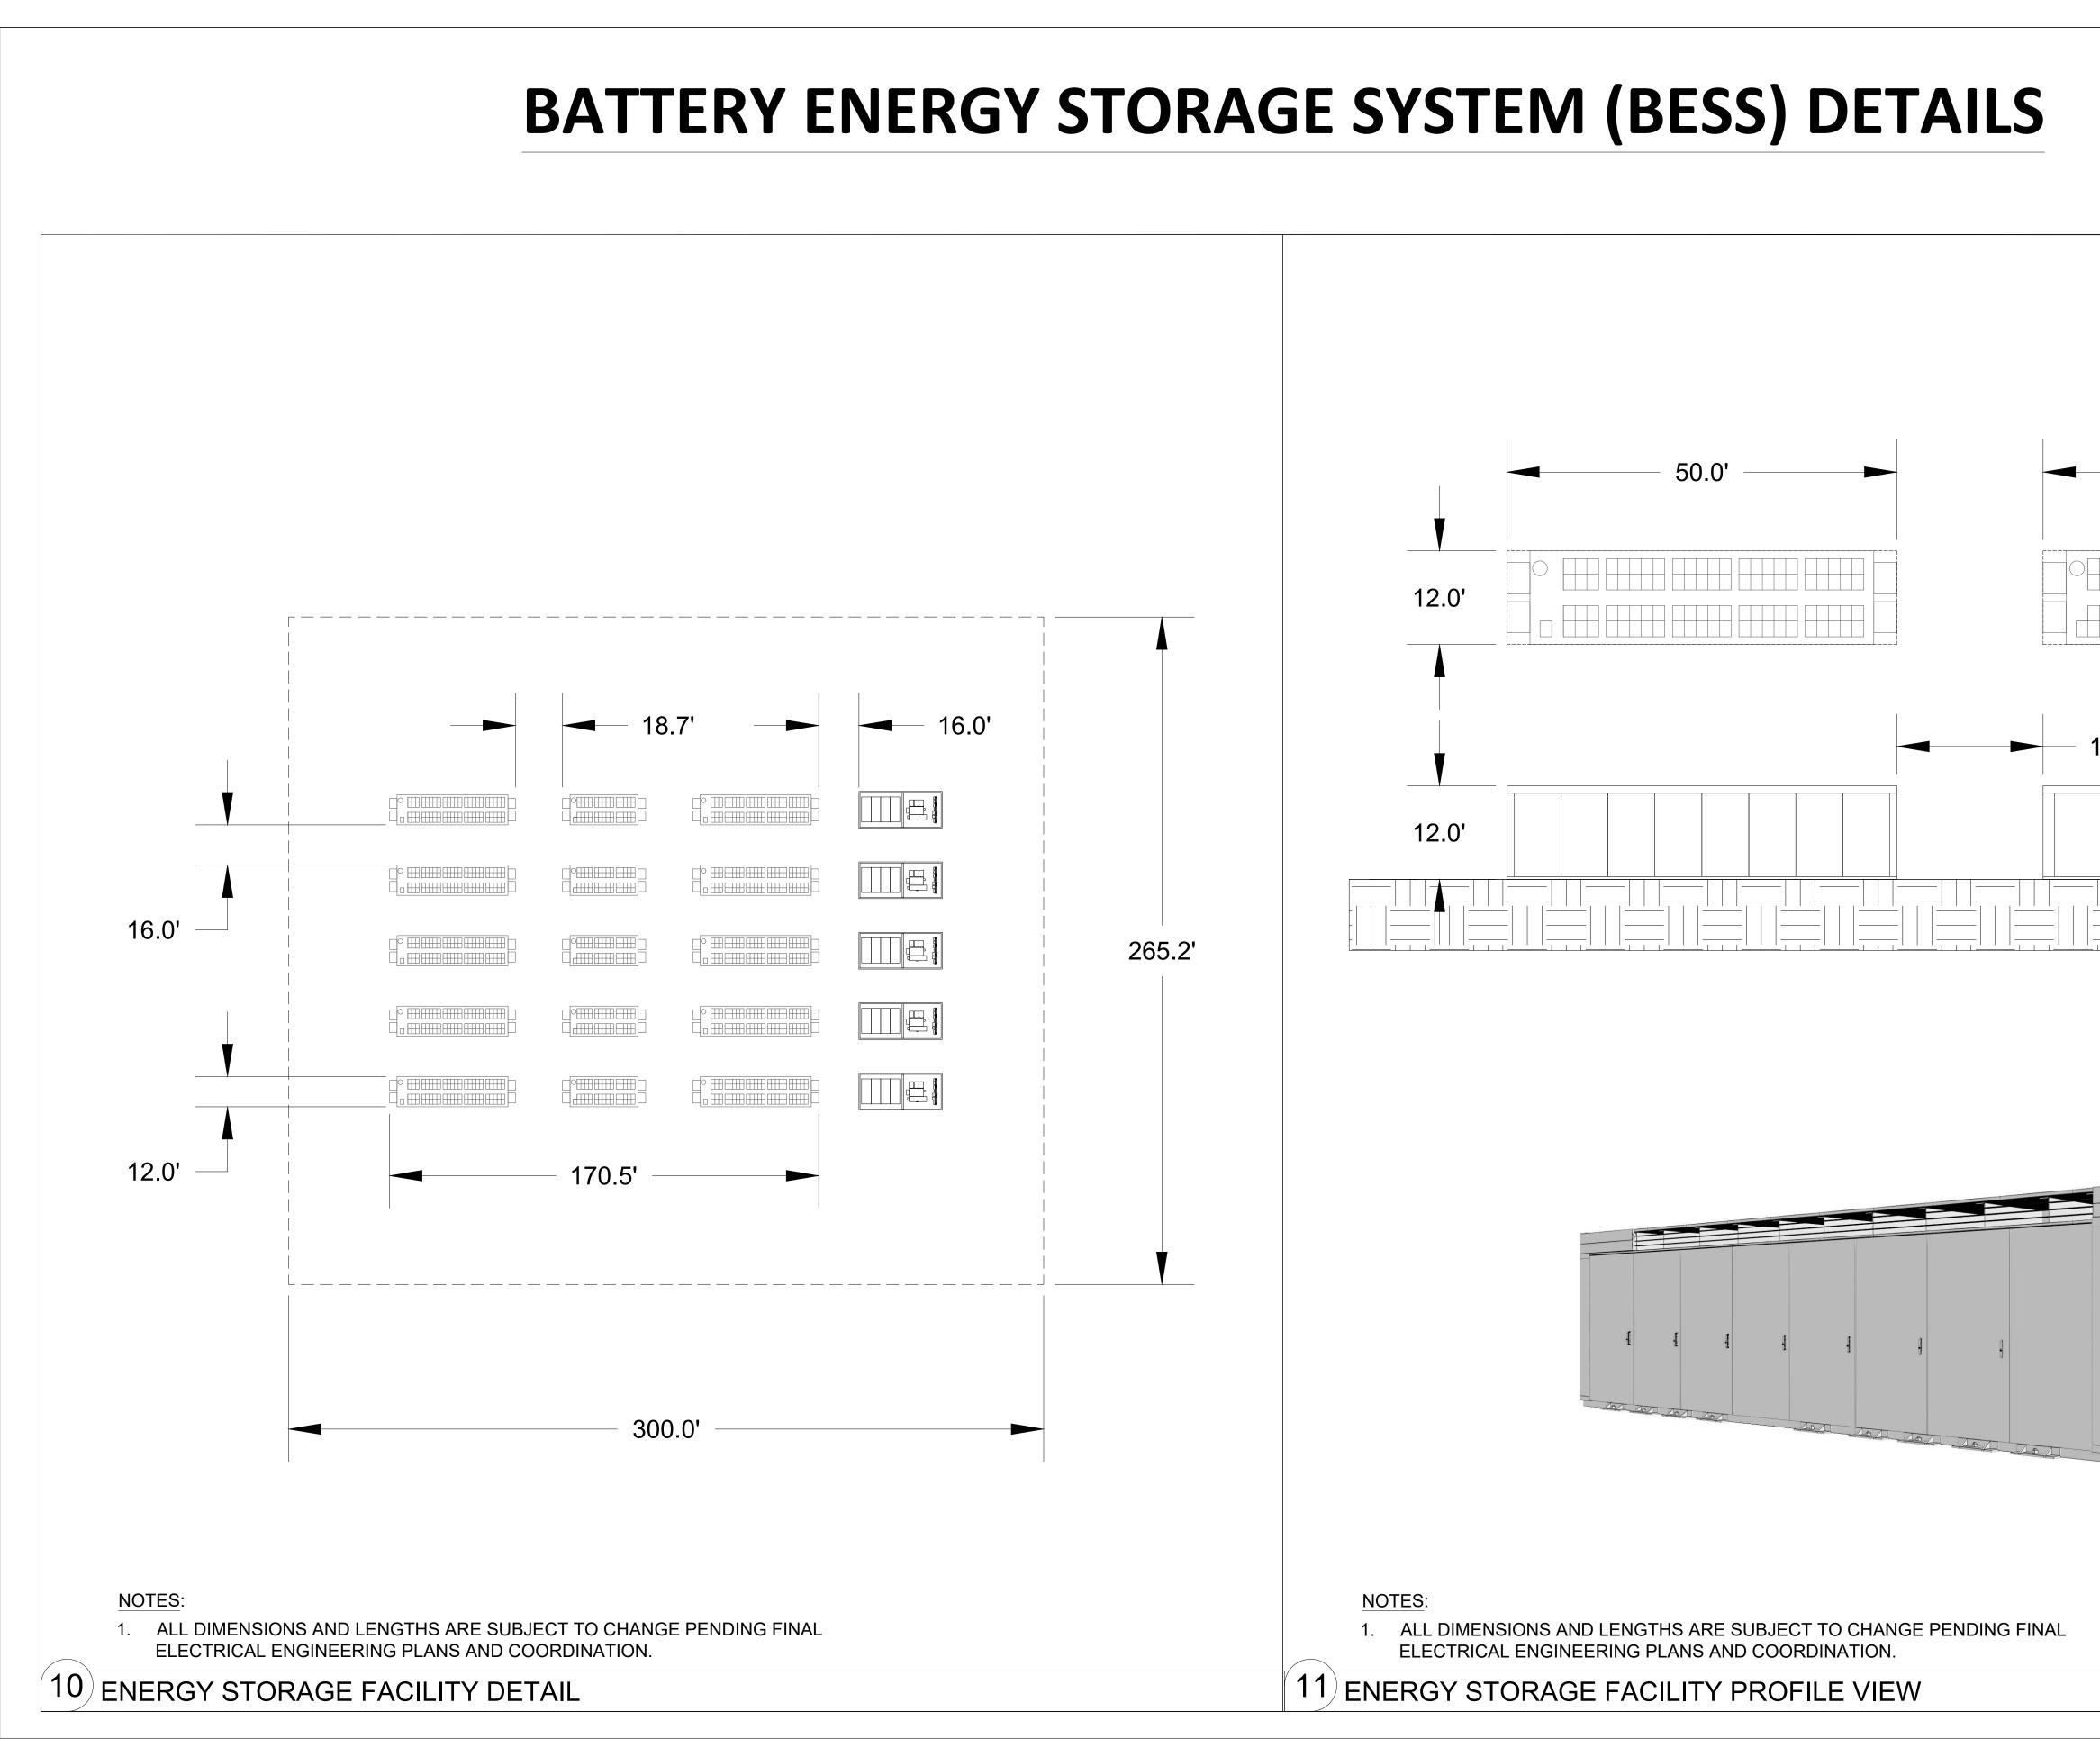

	REPRODUCTION, DISCLOSURE, OR USE WITHOUT	GRO	DUF	> LL	C
	PROJECT NUMBER:	IDDEN			
	SHEET TITLE: DETAILS				
	NOT FOR CONSTRUCTION	Q	RE	RE	RE
— 33.0' —		DATE	5/27/2025	6/2/2025	6/16/2025
	BLUEGRASS CREEK SOLAR BATTERY ENERGY STORAGE SYSTEM (BESS) DETAILS VANDERBURGH COUNTY, IN	REVISION	SITE PLAN - APC REVIEW (V1.1)	UPDATED SITE PLAN ANNOTATIONS, DETAILS (V1.2)	UPDATED SITE PLAN EXCLUSIONS, ANNOTATIONS, DETAILS (V1.3)
	BLUEGRA BATTERY ENERGY ST VANDE		SITE PLAN	UPDATED SITE PLAN	UPDATED SITE PLAN EXCLU
SCALE: NTS		#	1.1	1.2	1.3

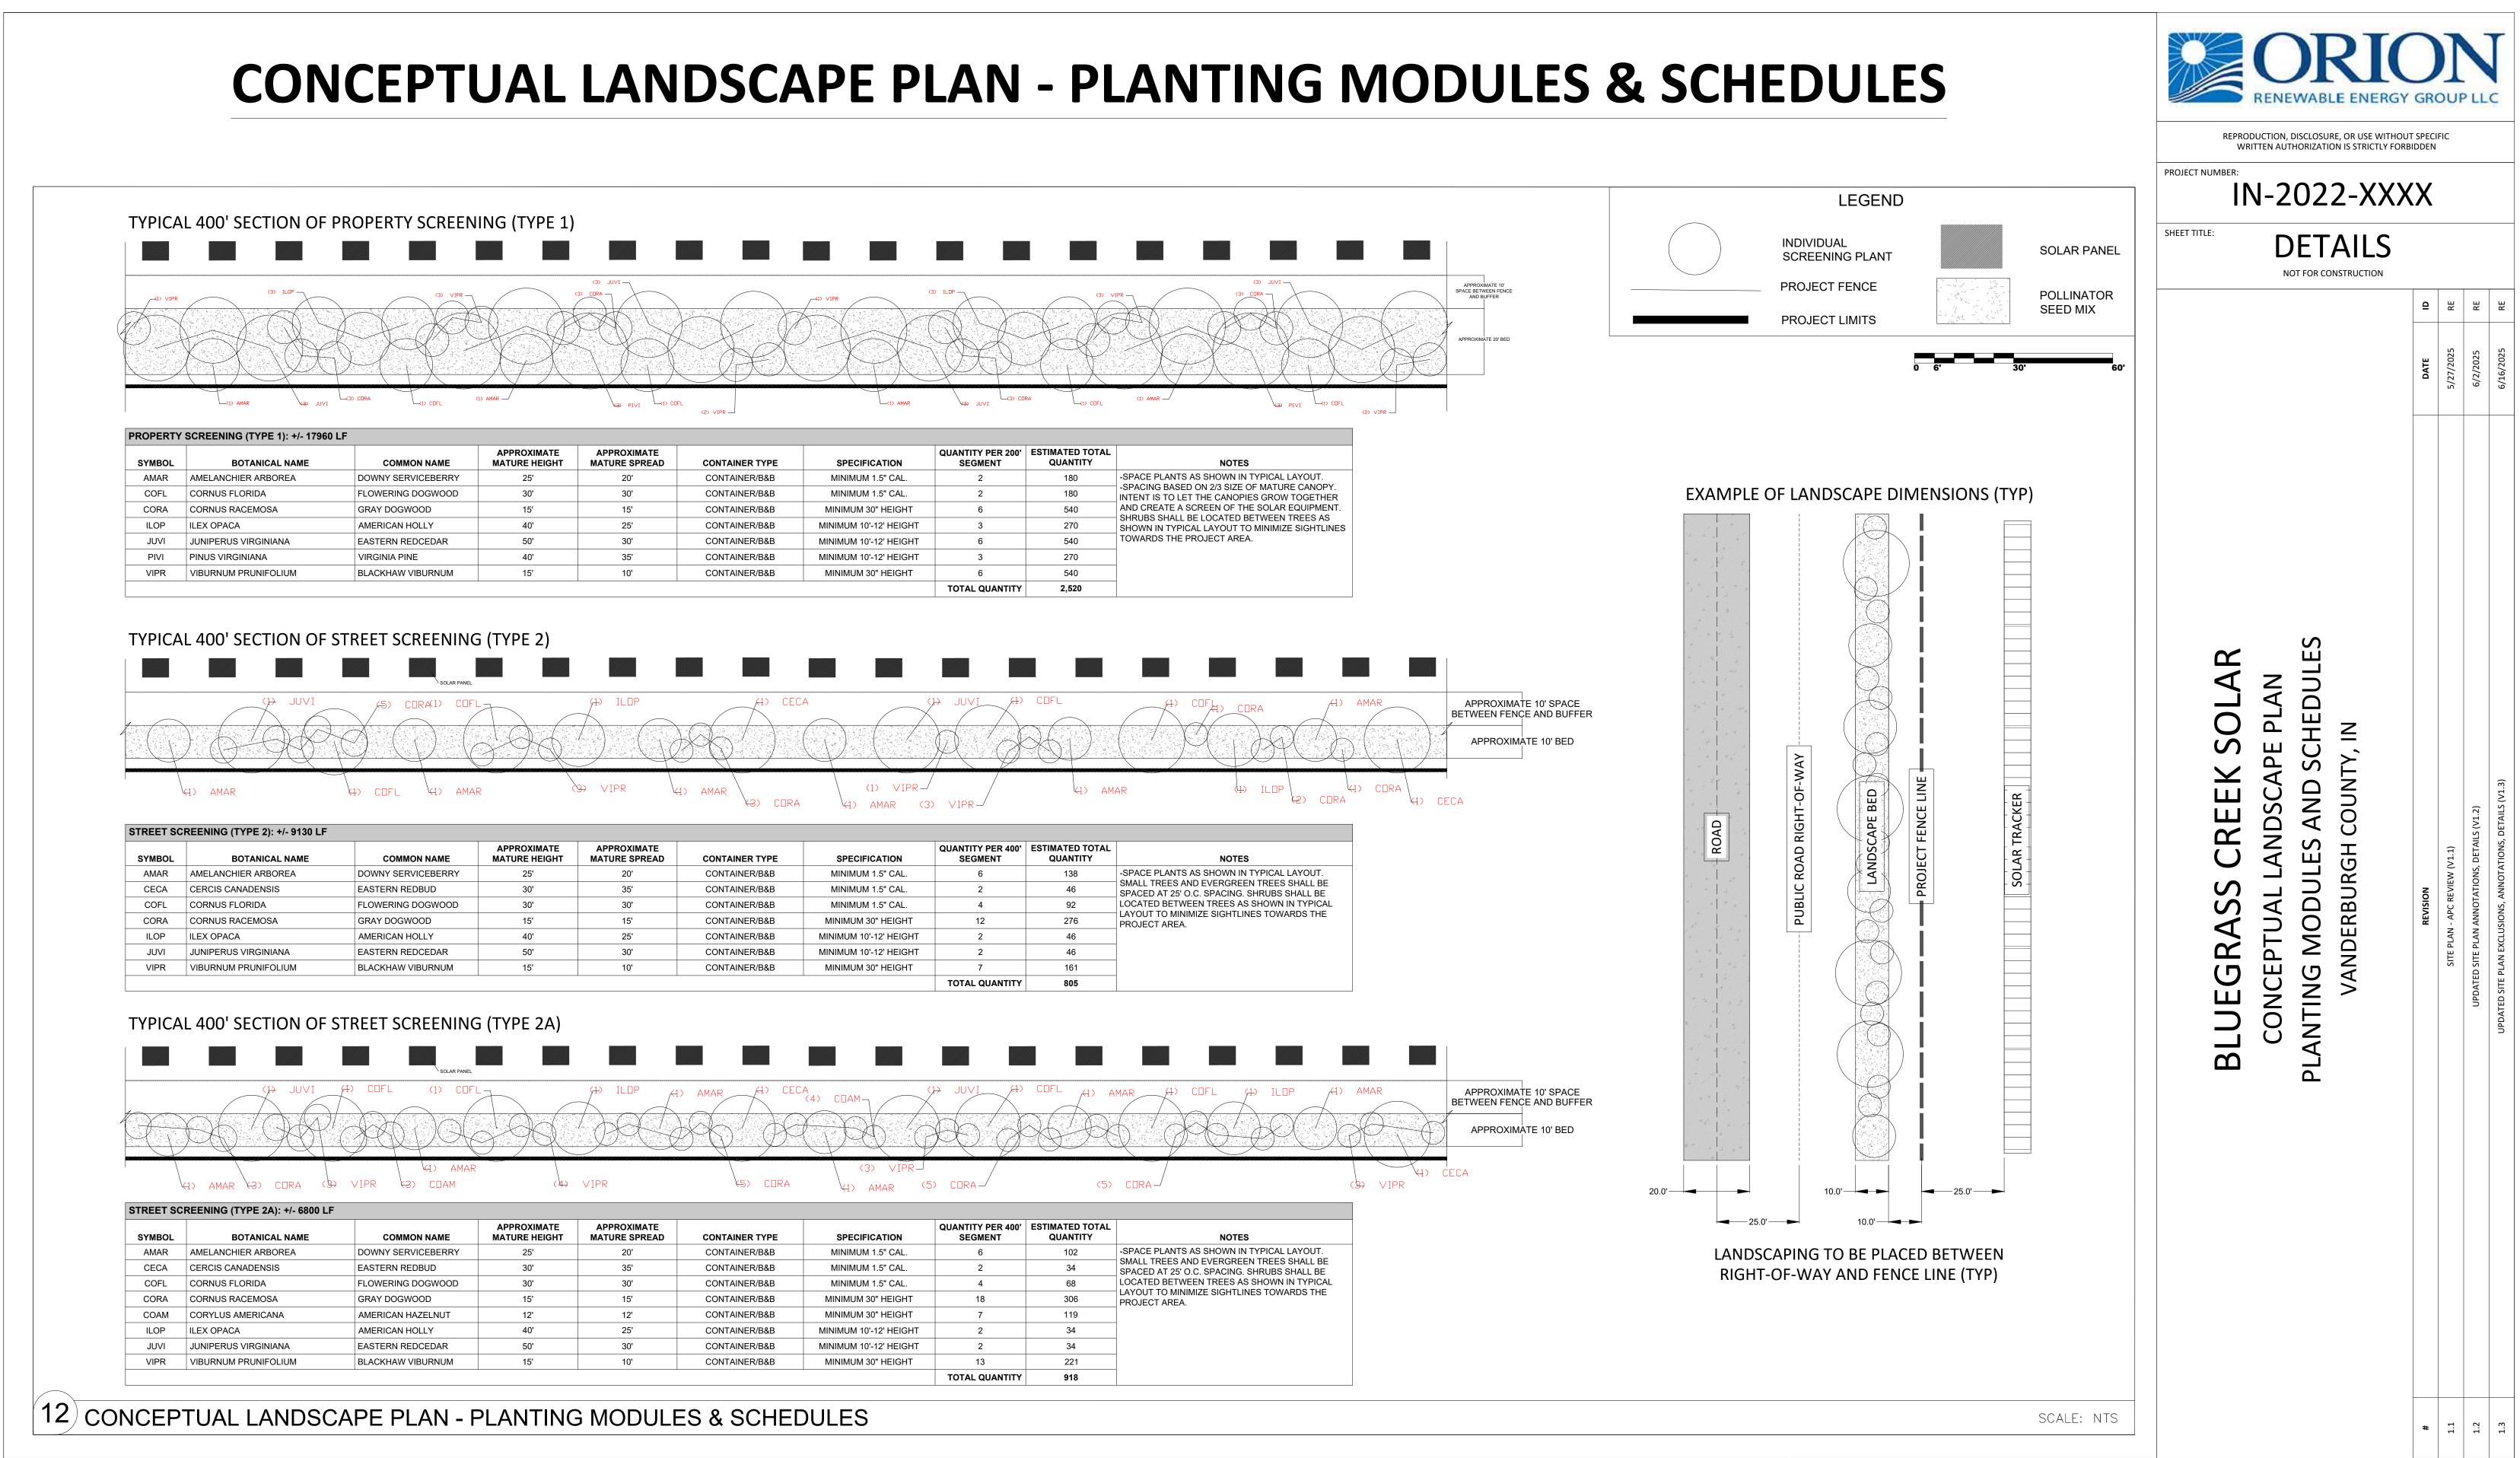

CONCEPTUAL LANDSCAPE PLAN - NOTES & DETAILS

VEGETATIVE SCREENING NOTES: TREE INSTALLATION

- 1. THE CONTRACTOR SHALL BE RESPONSIBLE FOR LAYOUT OF ALL WORK COVERED UNDER THESE PLANS.
- 2. ALL PLANT MATERIAL, UNLESS OTHERWISE SPECIFIED, SHALL BE UNIFORMLY BRANCHED AND HAVE A VIGOROUS ROOT SYSTEM. PLANT MATERIAL SHALL BE HEALTHY, VIGOROUS, AND FREE FROM DEFECTS, DECAY, DISEASES, INSECT PEST EGGS, AND ALL FORMS OF INFESTATION. ALL PLANT MATERIAL SHALL BE FRESH, FREE FROM TRANSPLANT SHOCK OR VISIBLE WILT. PLANTS DEEMED UNHEALTHY SHALL BE REJECTED.
- 3. ALL PLANT MATERIAL SHALL MEET THE MINIMUM SPECIFICATIONS AND STANDARDS DESCRIBED IN THE CURRENT ISSUE OF "THE AMERICAN STANDARD FOR NURSERY STOCK," PUBLISHED BY THE AMERICAN ASSOCIATION OF NURSERYMEN, 1250 I STREET, N.W., SUITE 500, WASHINGTON, D.C. 20005.
- 4. ALL CONTAINER STOCK SHALL HAVE BEEN PROPAGATED IN A CONTAINER LONG ENOUGH FOR THE ROOT SYSTEM TO HAVE DEVELOPED SUFFICIENTLY TO HOLD ITS SOIL. CONTAINER STOCK WITH POORLY DEVELOPED ROOT SYSTEMS SHALL NOT BE ACCEPTED.
- 5. PLANTS SHALL BE PREPARED FOR SHIPMENT IN A MANNER THAT SHALL NOT CAUSE DAMAGE TO THE BARK, BUDS, BRANCHES, STEMS, OR OVERALL SHAPE OF THE STOCK. CONTAINER GROWN PLANTS SHALL BE TRANSPORTED IN THE CONTAINERS IN WHICH THEY HAVE BEEN GROWN.
- 6. PLANTS NOT INSTALLED ON THE DAY OF ARRIVAL AT THE SITE SHALL BE STORED AND PROTECTED BY THE CONTRACTOR. OUTSIDE STORAGE AREAS SHALL BE SHADED AND PROTECTED FROM THE WIND AND SUN. PLANTS STORED ON SITE SHALL BE PROTECTED FROM ANY DRYING AT ALL TIMES BY COVERING THE BALLS OR ROOTS WITH MOIST SAWDUST, WET BURLAP, WOOD CHIPS, SHREDDED BARK, PEAT MOSS, OR OTHER SIMILAR MULCHING MATERIAL.
- 7. PLANT SUBSTITUTIONS MAY BE MADE BASED ON AVAILABILITY BUT MUST BE OF SIMILAR SIZE AND LANDSCAPE (SCREENING) VALUE. ALL SUBSTITUTIONS MUST BE APPROVED BY THE OWNER OR OWNER'S REPRESENTATIVE.
- 8. THE CONTRACTOR SHALL VERIFY ALL DIMENSIONS IN THE FIELD.
- 9. NO PLANTING SHALL OCCUR WHEN THE SOIL IS FROZEN.

PLANTING SEQUENCE

- 1. DIG THE PLANTING HOLE A MINIMUM OF 2x WIDTH OF ROOTBALL. DO NOT DIG THE HOLE DEEPER THAN ROOT BALL DEPTH.
- 2. HOLES FOR INDIVIDUAL PLANTINGS SHALL BE EXCAVATED TO PRODUCE VERTICAL SIDES AND FLAT BOTTOMS, ALL PLANTING HOLES SHALL HAVE ROUGHED, SCARIFIED SIDES AND BOTTOMS.
- 3. THE CONTRACTOR SHALL APPLY AGRIFORM FOREST STARTER TABLETS, OR EQUIVALENT PRODUCT, TO EACH PLANT AS PER MANUFACTURER'S DIRECTIONS ON LABEL AT TIME OF PLANTING.
- 4. LIFT AND SET THE TREE BY ROOT BALL ONLY. DO NOT LIFT USING THE TREE TRUNK AND DO NOT USE TREE TRUNK AS A LEVER.
- 5. SET THE TOP OF THE ROOT BALL LEVEL WITH THE SOIL SURFACE OR SLIGHTLY HIGHER IF THE SOIL IS PRONE TO SETTLING.
- 6. BACKFILL WITH EXISTING SOIL THAT HAS BEEN WELL-TILLED OR BROKEN UP.
- 7. PRUNING SHALL BE LIMITED TO DEAD, DISEASED, OR BROKEN LIMBS ONLY AND SHALL BE IN ACCORDANCE WITH ANSI A300 SPECIFICATIONS.
- 8. REMOVE ANY TRUNK WRAP REMAINING AT TIME OF PLANTING. NO WRAPS SHALL BE PLACED ON TRUNK.
- 9. THE CONTRACTOR SHALL RESTORE AREAS DISTURBED BY THE INSTALLATION OF SHRUBS AND TREES.
- 10. ONLY INDIVIDUAL PLANTS OR CLUSTERS OF PLANS SHALL BE MULCHED. THE REMAINING BUFFERYARD SHALL BE SEEDED WITH NATIVE POLLINATOR FRIENDLY SPECIES UNLESS ALREADY ESTABLISHED WITH NATIVE HERBACEOUS VEGETATION.
- 11. CONTRACTOR SHALL PROVIDE A 100% REPLACEMENT WARRANTY OF ALL LANDSCAPE PLANTINGS FOR A PERIOD OF THREE YEARS.

13) CONCEPTUAL LANDSCAPE PLAN - NOTES & DETAILS

