

## **ADDENDUM ACKNOWLEDGEMENT FORM**

IFB-030-01-25  
ADDENDUM #1

**Project No:** IFB-030-01-25 Architect's Project 2411-351  
**Project Title:** Renovations to METS Administrative Building and Transfer Terminal  
**Opening Date:** Thursday, September 18, 2025 @ 1:30 p.m.  
**Addendum Number:** (1) **Date:** September 12, 2025

PLEASE BE ADVISED THAT THE FOLLOWING CHANGES ARE APPLICABLE TO THE ORIGINAL SPECIFICATIONS OF THE ABOVE-REFERENCED IFB.

THE ADDENDUM NOW BECOMES A PART OF THE ORIGINAL IFB.

THIS *ADDENDUM ACKNOWLEDGEMENT FORM* SHALL BE SIGNED, DATED, AND RETURNED WITH THE RESPONSE BY AN AUTHORIZED COMPANY REPRESENTATIVE.

**COMPANY:** \_\_\_\_\_

**BY:** \_\_\_\_\_

**TITLE:** \_\_\_\_\_

**DATE:** \_\_\_\_\_

**PHONE NUMBER:** \_\_\_\_\_

**SIGNATURE:** \_\_\_\_\_



## ADDENDUM

Project:	METS Garage and Transfer Terminal Renovation 601 John St. / 6th and Sycamore St. Evansville, IN 47713 / 47708	Addendum No.:	001
		Date:	September 12, 2025
Owner:	Metropolotian Evansville Transit System (METS) 601 John Street Evansville, IN 47713	Project Number:	2411-351
		Contract for:	General

The original specifications and drawings dated August, 2025 for the project noted above are amended as noted in this Addendum Number 001. Receipt of this addendum and any subsequent addenda must be acknowledged on the final bid proposal. This addendum consists of 14 items and 7 attachments.

- 1-1 Pre-Bid Conference - Please refer to the attached sign-in sheet for attendees and companies represented.
- 1-2 Project Manual Table of Contents – Remove the following sections from the project manual:
  - Specification Section 012100 - Allowances. Do not include any allowances in the base bid or alternate bids.
  - Specification Section 099000 - Painting and Coating General Requirements.
- 1-3 Specification Section 096723 - Resinous Flooring – refer to sections 2.1 and 2.2 – change “HPC01” to “RF01”.
- 1-4 Specification Section 099123 – Interior Painting – Remove verbiage from 1.2-B subsections 4 (Section 099600 “High Performance Coatings”) and 5 (Section 099300 “Staining and Transparent Finishing” for surface preparation and the application of wood stains and transparent finishes on interior wood substrates).
- 1-5 Specification Section 105113 – Metal Lockers – At section 2.3.A, note “Lockers Manufacturing” as an approved manufacturer.
- 1-6 Drawing G1.1 – General Sheet – Refer to the attached, revised drawing G1.1 rev1 for updated information relative to Hardware Sets for doors.
- 1-7 Drawing D1.2 – Demolition Plan – East and North – Refer to the attached, revised drawing D1.2 rev1. Remove note “1” from the following rooms: Offices 7, 8, 9, 10, 11, 12, 13, Vending 6, Drivers Lounge 52, & Corridor 51.
- 1-8 Drawing A1.8 – Transfer Terminal Floor Plans and Roof Plan. Refer to the attached, revised drawing A1.8 rev1 for clarifications relative to the drawing name and wind screen scope of work.
- 1-9 Drawing ID1.0 – Garage Finish Legend and Schedule. Refer to the attached revised drawing ID1.0 rev1. Note Room Finish Schedule and Room Finish Schedule Comment changes.




- 1-10 Drawing ID1.1 – Garage Finish Plan West – Refer to the attached, revised drawing ID1.1 rev1. Refer to Finish Plan Reference Notes – Finish type updated in notes 6, 7, and 9.
- 1-11 Drawing ID1.2 – Garage Finish Plan East – Refer to the attached, revised drawing ID1.2 rev1. Refer to Finish Plan Reference Notes – Finish type updated in notes 6, 7, and 9.
- 1-12 Drawing ID1.2 – Garage Finish Plan East – Refer to the attached revised drawing ID1.2 rev 1. Finish Plan Reference Notes – Flooring scope to be replaced updated in note 8.
- 1-13 Clarification on Roller Window Shades – Reference Sheet ID1.0 Material Finish Legend section 122413 for shade types and styles. Reference sheet ID1.2 note 4 in room 30, RWS01 is mounted to existing doors to cover an approximate 2'-6"w x 3'-0"h window. Notes 13 in room 23, RWS01 is mounted to existing door to cover an approximate 2'-6"w x 3'-0"h window. Note 13 in rooms 22, 6, & 52, RWS01 is mounted between mullions, windows are approximately 3'-0"w x 2'-6"h. Note 13 in rooms 7, 8, 9, 10, 11, 12, & 13, RWS01 is mounted as shown in A1.5 detail 8, windows are approximately 2'-10"w x 1'-10"h. Reference sheet ID1.3 note 10 in room 70, RWS02 is mounted to the face of existing CMU wall, windows are approximately 6'-0"w x 7'-0"h and 7'-10"w x 9'-0"h. Sizes noted are for bidding purposes only, contractor shall field verify prior to ordering. Refer to the Alternates spec section 012300 – alternate no. 3 for scope of work.
- 1-14 Clarification of rubber base extents - Rooms 50 and 59 shall receive RB01 on new wall. Patch base from inside corner to inside corner with RB01 in rooms 30 and 59.

Attachments: Pre-Bid Sign In Sheet, G1.1 rev1, D1.2 rev1, A1.8 rev1, ID1.0 rev 1, ID1.1 rev 1, ID1.2 rev1

By: Tom Blythe, Avery Reiter

CC: Jonathan Siebeking, Alicia Hall



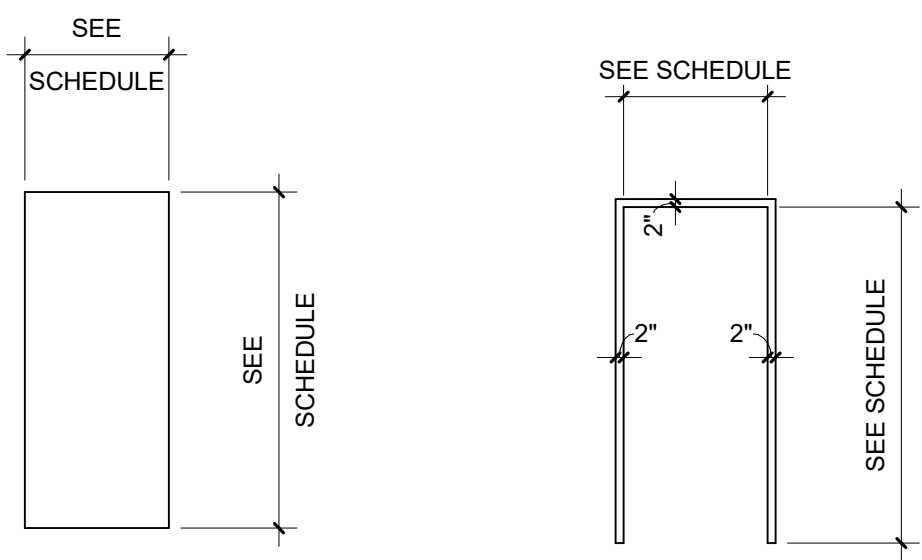


"F"  
FLUSH PANEL


F1

DOOR TYPE  
1/4" = 1'-0"

FRAME TYPE  
1/4" = 1'-0"

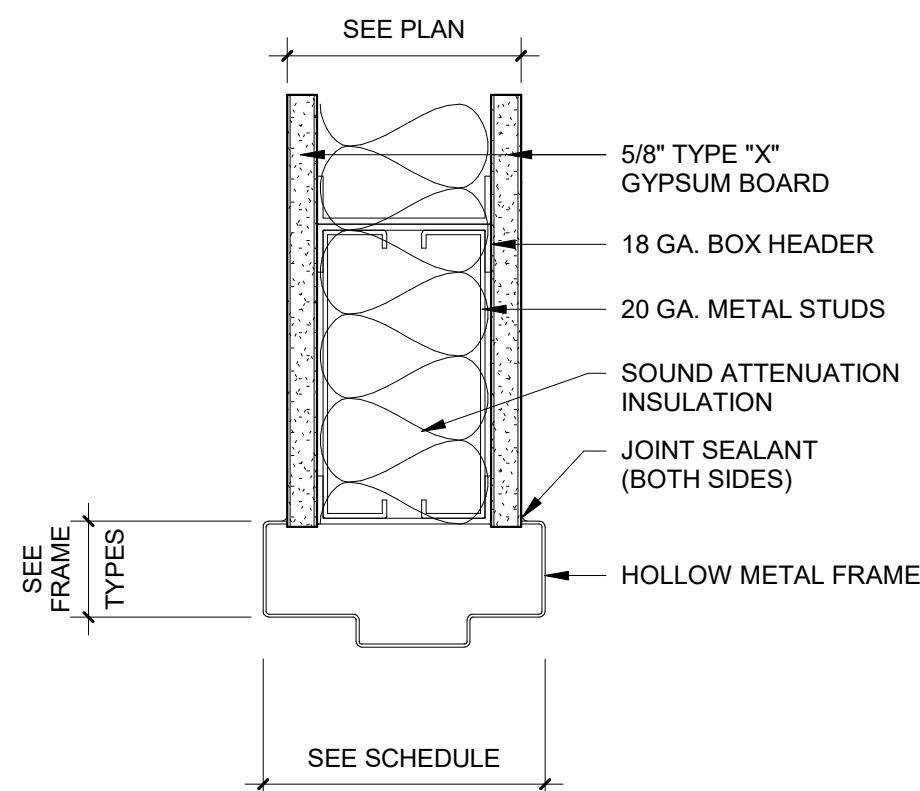

Drafting 6  
3" = 1'-0"

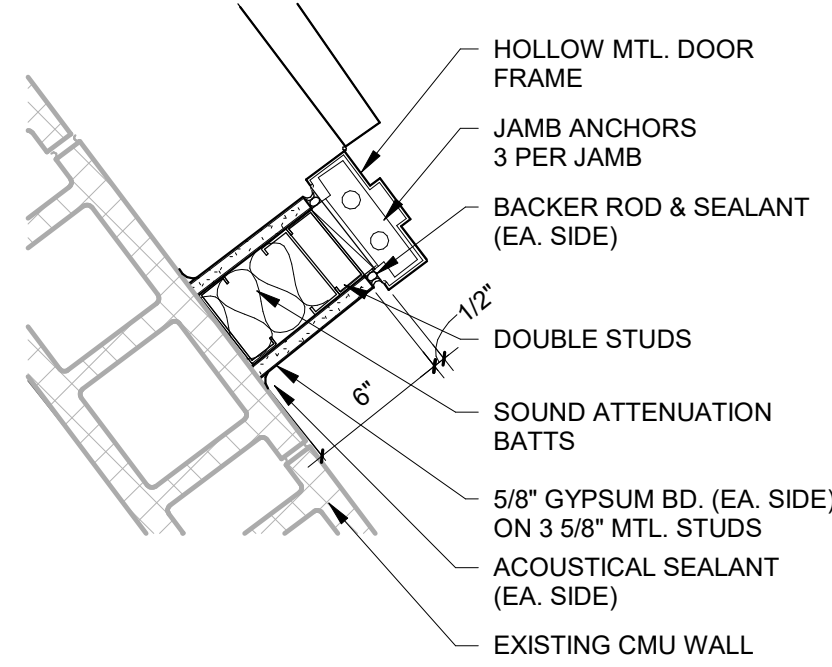

JAMB DETAIL  
1 1/2" = 1'-0"

## HARDWARE SETS:

Set No. 1 - Access Control at Existing Doors (confirm all preps)

Storeroom Lockset - Replace round knob, cylindrical lockset with new lever type Best Lockset (Storeroom Function)

Electric Strike - Replace existing strike with new HES 8300 electric stike

Card Reader - by others / rough-in by contractor

Set No. 2 - New Lockset at Restroom Doors

Privacy Lockset - Replace round knob, cylindrical lockset with new lever type Best Lockset (Privacy Function)

Set No. 3 - New Door and Frame

1 1/2 pair of hinges

Storeroom Lockset - Best with lever handle

Electric Strike - HES 8300

Wall Stop

Card Reader - by others / rough-in by contractor

## DOOR SCHEDULE COMMENTS:

- EXISTING DOOR / EXISTING FRAME
- NEW DOOR / EXISTING FRAME
- NEW DOOR / NEW FRAME

## DOOR SCHEDULE ABBREVIATIONS:


HM HOLLOW METAL  
WD SOLID CORE WOOD - ACROVYN DOOR

## HARDWARE SETS:

- NEW ELECTRONIC ACCESS ENTRY HARDWARE  
NEW LOCKSET (OFFICE FUNCTION)  
NEW CARD READER  
MAGNETIC HOLD OPEN
- NEW LOCKSET (OFFICE FUNCTION)
- 1 1/2 PR. HINGES  
NEW ELECTRONIC ACCESS ENTRY HARDWARE  
NEW CARD READER  
MAGNETIC HOLD OPEN  
WALL STOP

## DOOR SCHEDULE


Door Number	Fire Rating	Door Type	Door Data					Glass	Frame Data				Hardware Set	Comments	Door Number
			Material	Width	Height	Thickness	Type		Material	Depth	Head	Jamb			
44		F	WD	3'-0"	7'-0"	1 3/4"	-	F1	HM				1	1	44
47		F	WD	3'-0"	7'-0"	1 3/4"	-	F1	HM				2	1	47
48		F	WD	3'-0"	7'-0"	1 3/4"	-	F1	HM				2	1	48
49		F	WD	3'-0"	7'-0"	1 3/4"	-	F1	HM				1	1	49
51		F	WD	3'-0"	7'-0"	1 3/4"	-	F1	HM				1	1	51
52		F	WD	3'-0"	7'-0"	1 3/4"	-	F1	HM				1	1	52
55		F	WD	3'-0"	7'-0"	1 3/4"	-	F1	HM				1	1	55
56		F	WD	3'-0"	7'-0"	1 3/4"	-	F1	HM				1	1	56
57		F	WD	3'-0"	7'-0"	1 3/4"	-	F1	HM				1	1	57
58		F	WD	3'-0"	7'-0"	1 3/4"	-	F1	HM				1	1	58
60		F	WD	3'-0"	7'-0"	1 3/4"	-	F1	HM				1	1	60
62		F	WD	3'-0"	7'-0"	1 3/4"	-	F1	HM				1	1	62
163		F	WD	3'-0"	7'-0"	1 3/4"	-	F1	HM	5 3/4"	1/G1.1	2/G1.1	3	3	163
167		F	WD	3'-0"	7'-0"	1 3/4"	-	F1	HM				1	2	167

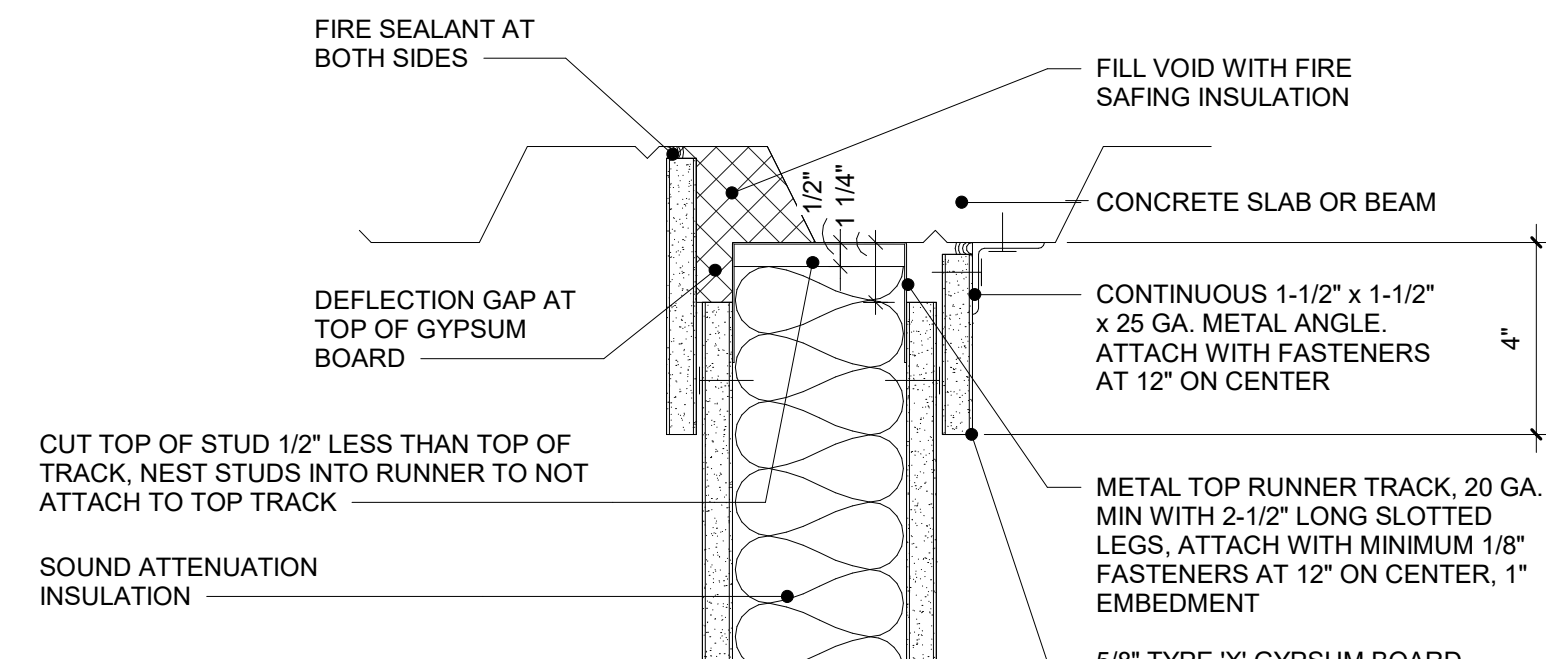

NOTE:  
2-HR ASSEMBLY INCORPORATES MULTIPLE LAYERS OF GYPSUM BOARD MATCHING NO. OF LAYERS ON STUD SURFACE.


## PARALLEL TO FLUTES

3" = 1'-0"

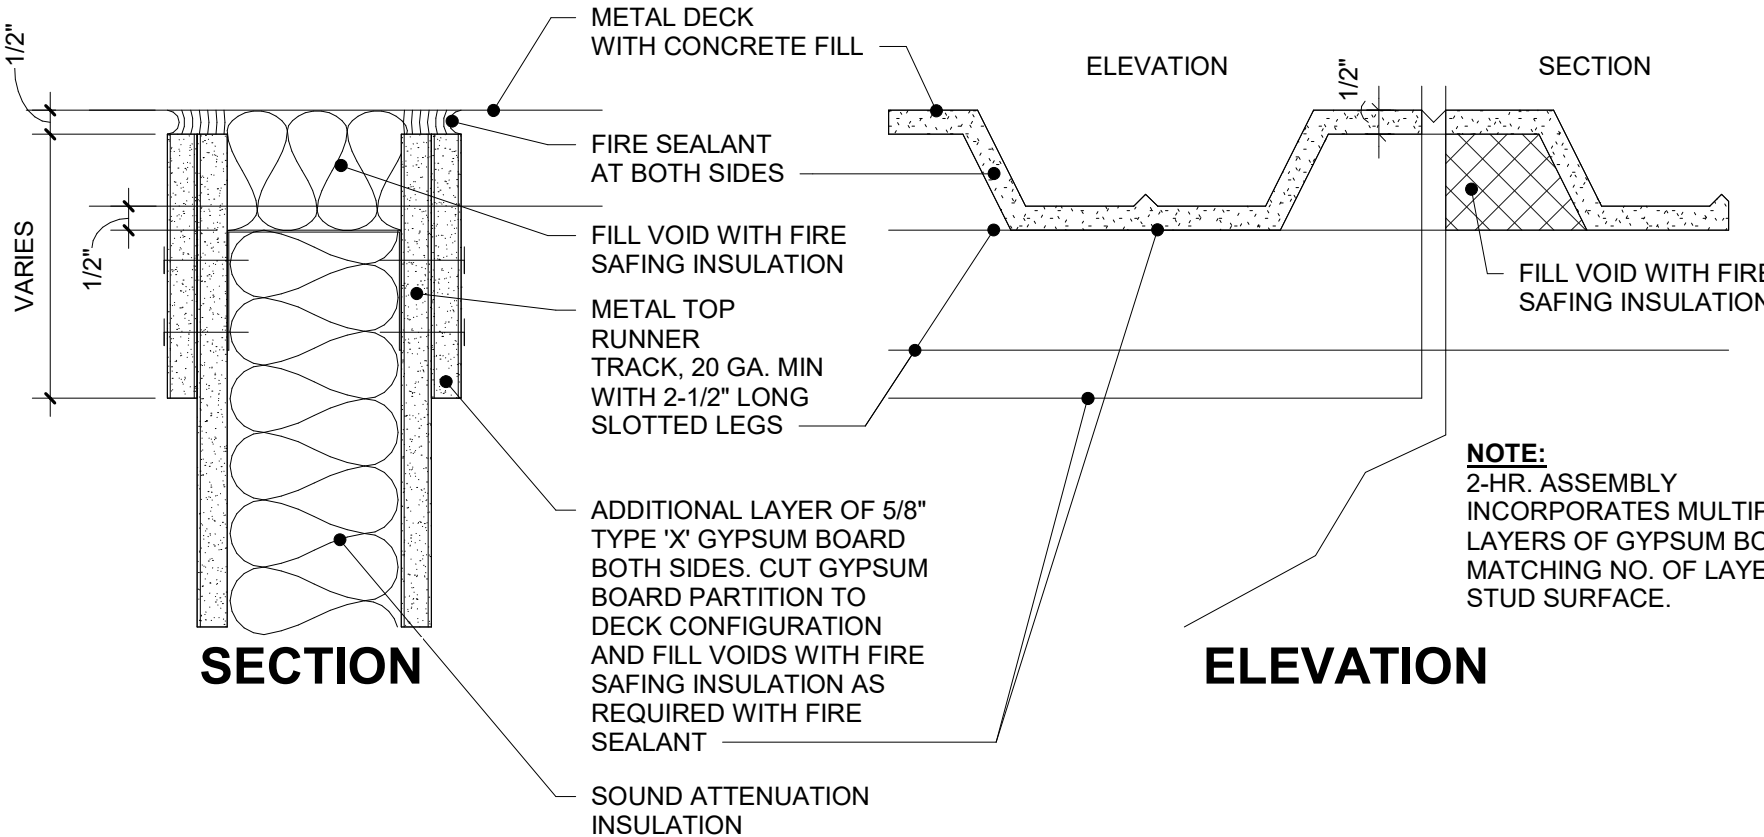

## PERPENDICULAR TO FLUTES

3" = 1'-0"

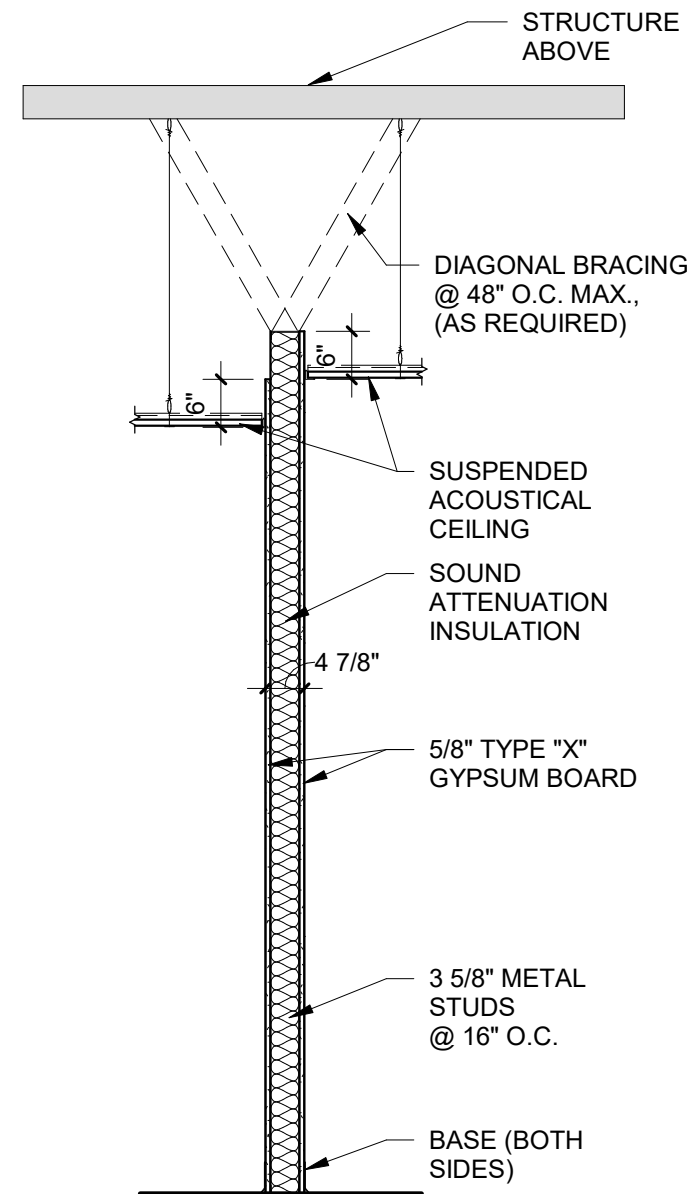


G3.B.1  
STC RATING 49 - SA-870717

## WALL TYPE SECTION

1/2" = 1'-0"

## REFERENCE SYMBOLS:

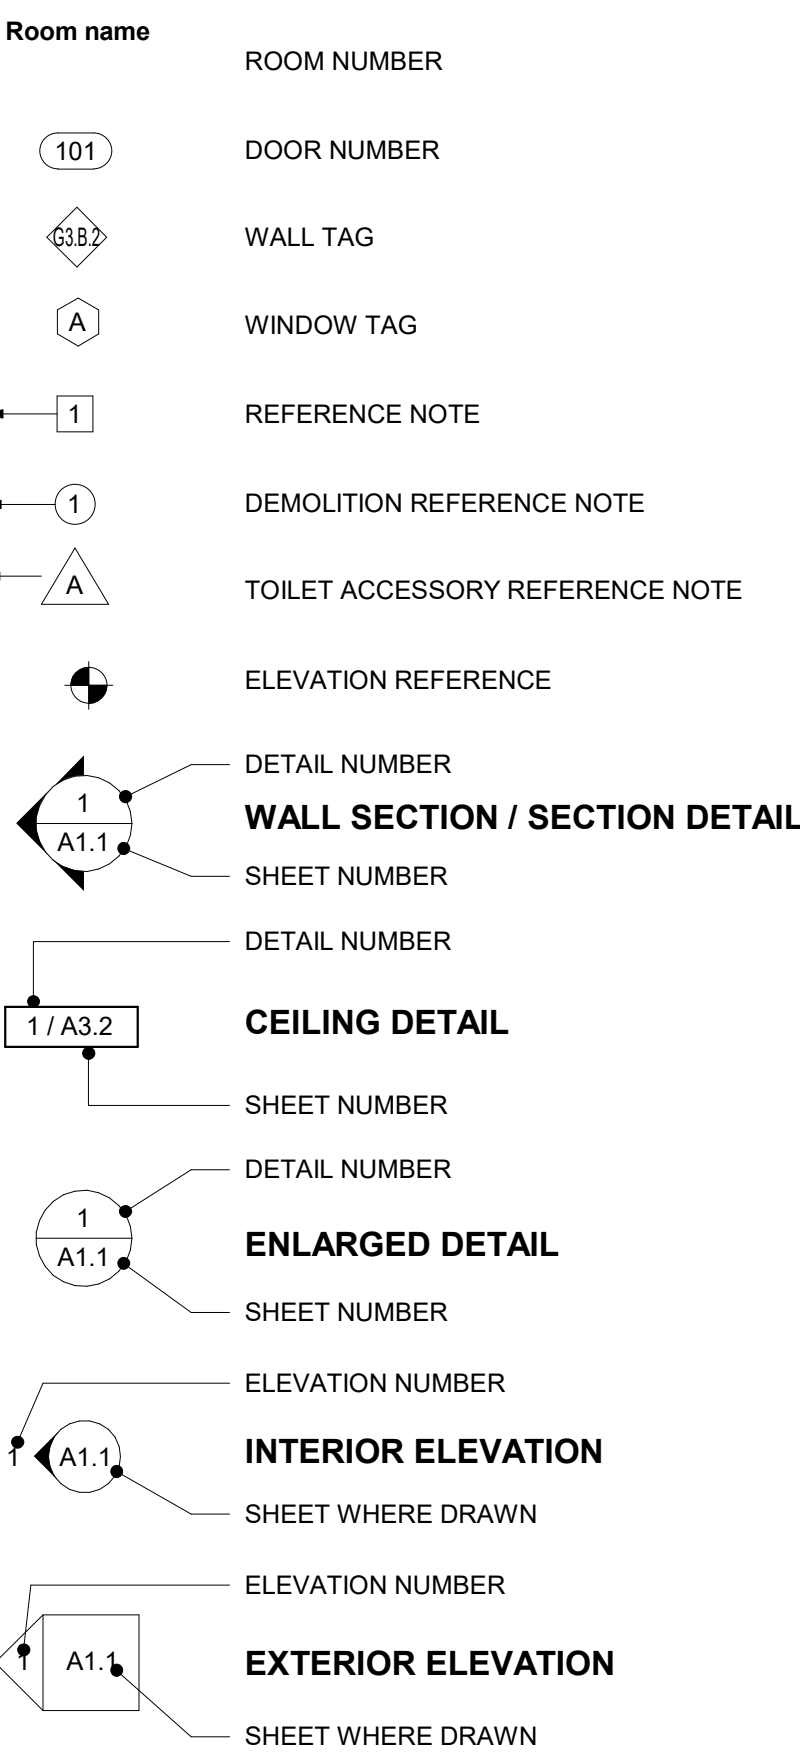

## COMMENTS:

- OFCI OWNER FURNISHED, CONTRACTOR INSTALLED  
OFOI OWNER FURNISHED, OWNER INSTALLED  
CFOI CONTRACTOR FURNISHED, OWNER INSTALLED  
CFCI CONTRACTOR FURNISHED, CONTRACTOR INSTALLED  
VFVI VENDOR FURNISHED, VENDOR INSTALLED  
VFCI VENDOR FURNISHED, CONTRACTOR INSTALLED

## NOTES:

- CONTRACTOR PROVIDE FINAL CONNECTIONS.  
CM TO COORDINATE ROUTING, PENETRATIONS AND FIRE STOPPING.

## WALL TYPE LEGEND

### MATERIAL

C	CAST-IN-PLACE CONCRETE
M	CONCRETE MASONRY UNIT
G	METAL STUD
W	WOOD STUD
S	SHAFTWALL

### NOMINAL/ ACTUAL SIZE

CAST-IN PLACE CONCRETE WALLS (EXAMPLE SIZE SHOWN, REFER TO STRUCTURAL)

12 12"

### MASONRY WALLS

4	3-5/8" CMU
6	5-5/8" CMU
8	7-5/8" CMU
10	9-5/8" CMU
12	11-5/8" CMU

### METAL STUD WALLS

0	7/8" FURRING
1	1-5/8" METAL STUD
2	2-1/2" METAL STUD
3	3-5/8" METAL STUD
4	4" METAL STUD
6	6" METAL STUD
8	8" METAL STUD
10	10" METAL STUD
12	12" METAL STUD

### WOOD STUD WALLS (ACTUAL)

2	2x2 WOOD STUD FURRING (1-1/2" x 1-1/2")
4	2x4 WOOD STUD (1-1/2" x 3-1/2")
6	2x6 WOOD STUD (1-1/2" x 5-1/2")
8	2x8 WOOD STUD (1-1/2" x 7-1/4")
10	2x10 WOOD STUD (1-1/2" x 9-1/4")
12	2x12 WOOD STUD (1-1/2" x 11-1/3")

### SHAFT WALL

2	2-1/2" C-H SHAFTWALL METAL STUDS
4	4" C-H SHAFTWALL METAL STUDS

## SURFACES

A	1 LAYER 5/8" TYPE "X" GYP. BD. ON ONE SIDE OF METAL STUD WALL
B	1 LAYER 5/8" TYPE "X" GYP. BD. ON EACH SIDE OF METAL STUD WALL
C	2 LAYERS 5/8" TYPE "X" GYP. BD. ON EACH SIDE OF METAL STUD WALL
D	2 LAYERS 5/8" TYPE "X" GYP. BD. ON ONE SIDE AND 1" GYPSUM LINER PANEL ON OPPOSITE.
E	3 LAYERS 5/8" TYPE "X" GYP. BD. ON ONE SIDE AND 1" GYPSUM LINER PANEL ON OPPOSITE.

## CONDITIONS

1	WALL AND FINISH EXTENDS 6" ABOVE HIGHEST ADJOINING CEILING. BRACE TOP OF WALL AS REQUIRED.
2	EXTEND WALL AND ONE SIDE OF GYPSUM BD. (EXPOSED SIDE IF NO CEILING) TO STRUCTURE ABOVE. (REFER TO HEAD OF WALL DETAILS AND SMOKE/ FIRE RATINGS)
3	EXTEND WALL AND BOTH SIDES OF GYPSUM BD. TO STRUCTURE ABOVE. (REFER TO HEAD OF WALL DETAILS AND SMOKE/ FIRE RATINGS)

## EXAMPLE

G3.B.3	3-5/8" METAL STUD WITH 5/8" TYPE "X" GYP. BD. EACH SIDE. EXTEND WALL AND BOTH SIDES OF GYPSUM BD. TO STRUCTURE ABOVE.
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## GENERAL NOTES

- ALL PARTITIONS EXTEND TO ROOF OR FLOOR STRUCTURE ABOVE UNLESS NOTED OTHERWISE.
- REFER TO LIFE SAFETY PLAN FOR FURTHER INFORMATION REGARDING FIRE/ SMOKE RATINGS AND LOCATIONS.
- REFER TO EXTERIOR WALL SECTIONS AND DETAILS FOR EXTERIOR WALL MATERIALS AND FINISHES.
- STORAGE ROOMS GREATER THAN 100 SF SHALL BE CONSTRUCTED TO RESIST THE PASSAGE OF SMOKE.
- PROVIDE 25 GAUGE METAL STUDS, UNLESS NOTED OTHERWISE OR REQUIRED BY METAL STUD GAUGE SELECTION CHART.
- PROVIDE (2) 20 GAUGE METAL STUDS AT ALL WINDOW AND DOOR JAMBS.
- ALL FIRE-RATED PARTITIONS ARE TO BE CONSTRUCTED IN ACCORDANCE WITH APPROPRIATE U.L. ASSEMBLY.
- REFER TO REFLECTED CEILING PLANS FOR LOCATIONS OF SOUND ATTENUATION BLANKETS. - **THIS NOTE SHALL BE REMOVED ON HEALTHCARE PROJECTS**
- PARTITIONS NOT REQUIRED TO EXTEND TO FLOOR OR ROOF STRUCTURE ABOVE SHALL BE BRACED BY ATTACHING ALTERNATING DIAGONAL STUDS 48" O.C. (MAX.) FROM TOP OF PARTITION TO STRUCTURE ABOVE.
- FIRE RATED WALLS TO RECEIVE ELECTRICAL OUTLET BOXES SHALL CONFORM TO THE FOLLOWING GUIDELINES. METALLIC OUTLET BOXES SHALL BE UTILIZED IN WALLS AND PARTITIONS WITH A TWO HOUR OR LESS CLASSIFICATION. THE SURFACE AREA OF INDIVIDUAL BOXES SHALL NOT EXCEED 16 SQUARE INCHES. THE AGGREGATE SURFACE AREA OF BOXES SHALL NOT EXCEED 100 SQUARE INCHES IN ANY 100 SQUARE FEET. BOXES LOCATED ON OPPOSITE SIDES OF RATED WALL OR PARTITIONS SHALL BE SEPARATED BY A MINIMUM HORIZONTAL DISTANCE OF 24 INCHES.

## INTERIOR PARTITION METAL STUD GAUGE SELECTION CHART

16" O.C. STUD SPACING WITH ALLOWABLE DEFLECTION CRITERIA OF L/360

STUD DEPTH	MAXIMUM VERTICAL UNBRACED SPAN IN FEET	MAXIMUM VERTICAL UNBRACED SPAN IN FEET	STUD GAUGE
	(1 LAYER GYPSUM BOARD EACH SIDE)	(2 LAYER GYPSUM BOARD EACH SIDE)	
1-5/8"	8'-3"	9'-0"	25
2-1/2"	10'-9"	11'-4"	25
2-1/2"	11'-6"	12'-3"	22
2-1/2"	12'-0"	14'-0"	20
3-5/8"	14'-0"	14'-9"	25
3-5/8"	15'-0"	15'-9"	22
3-5/8"	15'-0"	17'-9"	20
4"	15'-0"	18'-0"	25
4"	16'-3"	16'-9"	22
4"	16'-10"	16'-11"	20
6"	20'-0"	20'-0"	25
6"	22'-0"	22'-9"	22
6"	22'-10"	24'-11"	20

Renovations to METS Garage and Transfer Terminal



Garage - 601 John St. Evansville, IN 47713  
Transfer Terminal - Sixth St. & Sycamore St. Evansville, IN 47630

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In association with:



Thomas W. Blythe

## Revisions:

#	Description	Date
1	ADD-001	2025/09/12

Designed By: Drawn By: Checked By:

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Sheet title:

## GENERAL SHEET


Architect's Project No: Date:

2411-351 August, 2025

Drawing No:

G1.1



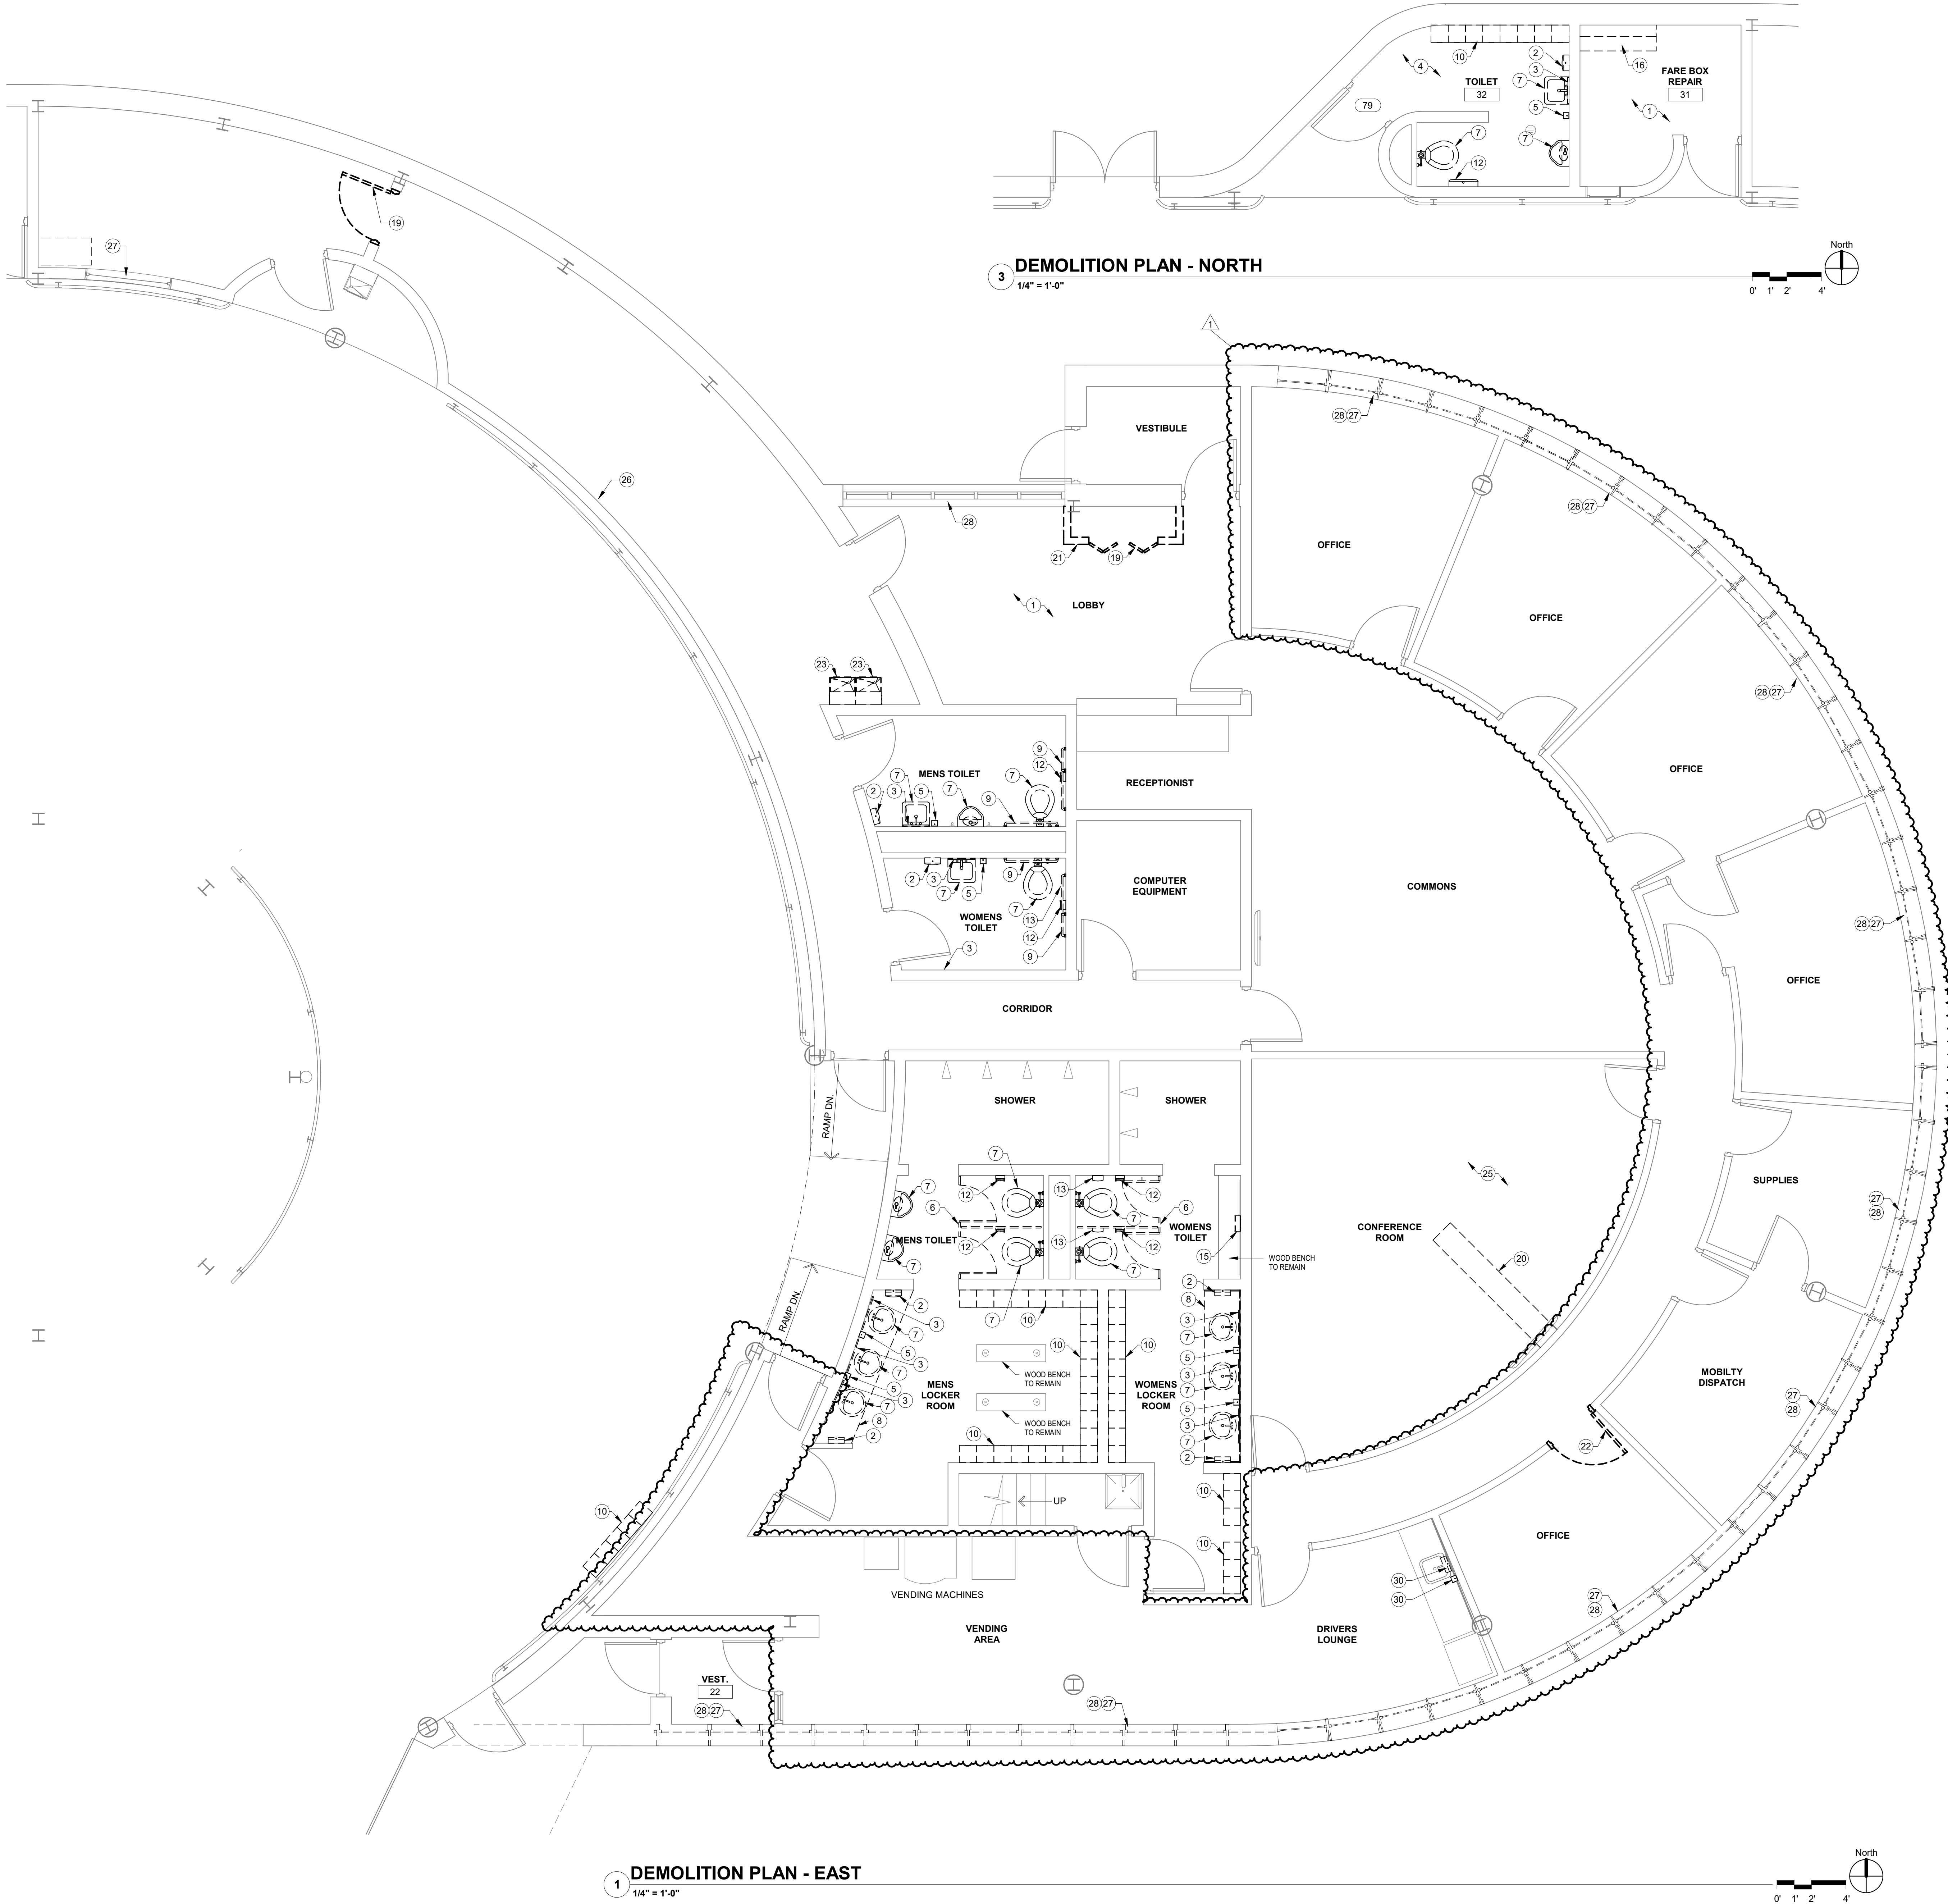

DEMO PLAN REFERENCE NOTES:

- 1 REMOVE EXISTING FLOOR FINISH AND BASE.
- 2 REMOVE EXISTING WALL-MOUNTED PAPER TOWEL DISPENSER.
- 3 REMOVE EXISTING WALL-MOUNTED MIRROR.
- 4 CLEAN AND PREPARE FLOOR FOR NEW FINISH.
- 5 REMOVE EXISTING WALL-MOUNTED SOAP DISPENSER
- 6 REMOVE EXISTING TOILET PARTITIONS AND ACCESSORIES.
- 7 REMOVE EXISTING PLUMBING FIXTURE - REFER TO PLUMBING DWGS.
- 8 REMOVE EXISTING COUNTERTOP
- 9 REMOVE EXISTING GRAB BARS
- 10 REMOVE EXISTING METAL LOCKERS
- 11 CLEAN AND PREP EXISTING DOOR AND FRAME TO RECEIVE NEW FINISH.
- 12 REMOVE EXISTING TOILET TISSUE DISPENSER
- 13 REMOVE EXISTING SANITARY NAPKIN DISPOSAL
- 14 NOT USED
- 15 REMOVE EXISTING SEAT COVER DISPENSER
- 16 REMOVE EXISTING CABINETRY
- 17 REMOVE EXISTING URINAL SCREEN
- 18 REMOVE EXISTING BABY CHANGING STATION
- 19 REMOVE EXISTING DOOR AND FRAME
- 20 REMOVE PORTION OF EXISTING FLOOR, AS REQUIRED FOR NEW WORK. SALVAGE CARPET TILE TO BE RE-INSTALLED DURING NEW CONSTRUCTION. USE OWNER ATTIC STOCK OF CPT01 AS REQUIRED.
- 21 REMOVE EXISTING WALL
- 22 REMOVE EXISTING DOOR. EXISTING FRAME TO REMAIN
- 23 REMOVE EXISTING DRINKING FOUNTAIN
- 24 REMOVE EXISTING WIRE PARTITION
- 25 PROTECT EXISTING TO REMAIN FLOORING DURING DEMOLITION AND NEW CONSTRUCTION.
- 26 REMOVE DAMAGED LVT FLOORING. PATCH WITH LVT01.
- 27 ALTERNATE 2: REMOVE EXISTING WINDOW SHADES.
- 28 REMOVE PLASTIC LAMINATE WINDOW SILL CLADDING. REPLACE WITH PLASTIC LAMINATED PLYWOOD, PLO2, TO MATCH EXISTING LAYOUT AND DIMENSIONS.
- 29 REMOVE EXISTING SCONCE LIGHTS. PATCH AND REPAINT.
- 30 REMOVE EXISTING WALL MOUNTED ITEM, SALVAGE FOR OWNER DIRECTED RE-INSTALLATION.
- 31 REMOVE EXISTING WINDOW BLIND.
- 32 PROTECT EXISTING BRICK TO REMAIN DURING DEMOLITION AND NEW CONSTRUCTION.

GENERAL DEMOLITION NOTES:

- A FIELD VERIFY ALL EXISTING CONDITIONS. NOTIFY ARCHITECT / ENGINEER IMMEDIATELY OF ANY DISCREPANCIES THAT EXIST.
- B REMOVE EXISTING CONSTRUCTION AS NOTED AND WHERE SHOWN DASHED. CONTRACTOR IS RESPONSIBLE FOR ALL DEMOLITION REQUIRED FOR THE INSTALLATION OF NEW WORK, AND FOR PROTECTION OF ITEMS TO REMAIN.
- C CONTRACTOR IS RESPONSIBLE FOR ANY DEMOLITION THAT IS NOT SHOWN ON DEMOLITION DRAWINGS BUT IS REQUIRED FOR NEW CONSTRUCTION.
- D IF CONTRACTOR BECOMES AWARE OF ANY LOAD BEARING POINTS WITHIN DEMOLITION NOT NOTED ON THE DRAWINGS, THE CONTRACTOR SHALL IMMEDIATELY NOTIFY ARCHITECT / ENGINEER PRIOR TO REMOVING THE CONSTRUCTION.
- E PATCH OPENINGS IN WALLS, CEILINGS AND FLOORS RESULTING FROM DEMOLITION WORK. PATCH WITH MATCHING MATERIALS AND CONSTRUCTION UNLESS NOTED OTHERWISE.
- F THE OWNER HAS FIRST RIGHT OF REFUSAL OF ALL SALVAGEABLE ITEMS REMOVED DURING DEMOLITION INCLUDING FURNISHINGS.
- G CUT OPENINGS IN FLOOR AND ROOF STRUCTURE FOR NEW MECHANICAL AND ELECTRICAL DUCTWORK, PIPING AND CONDUIT. REINFORCE OPENINGS AS REQUIRED. SAW CUT AND PATCH EXISTING FLOOR SLABS AS REQUIRED FOR NEW PIPING. REFER TO PLUMBING DRAWINGS.
- H REFER TO MECHANICAL/ELECTRICAL PLANS AND SPECIFICATIONS FOR REMOVAL/RELOCATION/ROUTING OF EXISTING UTILITIES.
- I DEMOLITION OF EXISTING UTILITIES SHALL BE MADE SO THAT SERVICE TO OTHER AREAS UTILIZED BY THE OWNER ARE NOT INTERRUPTED. PROVIDE TEMPORARY UTILITIES, ISOLATION VALVES, DISCONNECTS, ETC. WHERE REQUIRED DURING DEMOLITION AND NEW CONSTRUCTION.
- J WHERE EXISTING ELECTRICAL DEVICES ARE INDICATED TO BE REMOVED, REPAIR WALL AS REQUIRED TO MATCH EXISTING (TO REMAIN) WALL FINISH. PATCH WALL AS REQUIRED TO RECEIVE NEW FINISHES FOR A SMOOTH, FLUSH APPEARANCE.
- K REMOVE EXISTING CEILINGS WHERE REFLECTED CEILING PLANS INDICATE NEW CEILINGS.
- L REMOVE ALL EXISTING FLOOR FINISHES, ADHESIVES AND WALL BASE WHERE NEW FLOOR FINISH IS REQUIRED. REFER TO ROOM FINISH SCHEDULE. PREPARE EXISTING FLOOR SUBSTRATE TO RECEIVE NEW FLOOR FINISHES AS RECOMMENDED BY FLOOR FINISH MANUFACTURER.
- M PROVIDE DUST BARRIERS AS REQUIRED TO PREVENT MIGRATION TO AREAS TO BE OCCUPIED BY OWNER. PROTECT ALL EQUIPMENT TO REMAIN. COORDINATE PROTECTION OF EXISTING EQUIPMENT WITH OWNER.
- N COORDINATE DEMOLITION WITH SEQUENCING OF THE WORK.
- O PROTECT EXISTING FINISHES WHICH ARE TO REMAIN.
- P CONDUCT DEMOLITION ACTIVITIES CLEANLY, COMPLETELY AND IN A MANNER SUITABLE FOR NEW FINISHES.
- Q WHILE DEMOLITION IS OCCURRING, SENSITIVE OWNER ACTIVITIES WILL BE PROCEEDING IN ADJACENT AREAS. MINIMIZE NOISE AND DUST LEVELS AND TEMPORARILY SUSPEND DEMOLITION AS REQUESTED BY THE OWNER.
- R PROVIDE TEMPORARY PARTITIONS TO MAINTAIN PROPER FIRE EXITS AND TO CONFINE PEDESTRIAN ACTIVITY TO OCCUPIED SPACES MAINTAIN REQUIRED MEANS OF EGRESS AND SIGNAGE FOR EGRESS.
- S WHERE DEMOLITION ACTIVITY DAMAGES OR REMOVES ANY APPLIED FIREPROOFING OR CONSTRUCTION INSTALLED AS PART OF A RATED ASSEMBLY, REPLACE FIREPROOFING AND CONSTRUCTION MATERIALS TO ACHIEVE AND MAINTAIN APPROPRIATE ASSEMBLY RATING.
- T VERIFY FLOOR ELEVATIONS ON EACH SIDE OF WALLS BEING REMOVED. GRIND AND PATCH FLOOR AND INSTALL EPOXY FILL MATERIAL AS REQUIRED FOR A SMOOTH LEVEL FLOOR CONDITION.
- U THE CONTRACTOR SHALL BE RESPONSIBLE FOR THE CLEAN-UP COST FOR DUST AND DEBRIS WHICH MIGRATE INTO EXISTING, ADJACENT SPACES.
- V REMOVE ALL EXISTING WALL-MOUNTED ITEMS WITHIN THE PROJECT LIMITS WHICH ARE NOT INDICATED TO REMAIN. IF ITEMS ARE REMOVED FROM WALLS OR COLUMNS THAT REMAIN, PATCH WALLS AND COLUMNS AS REQUIRED TO RECEIVE NEW FINISHES.
- W PATCH ALL FLOOR PENETRATIONS RESULTING FROM REMOVAL OF EXISTING DUCTWORK, PIPING ELECTRICAL RACEWAYS, ETC. FILL PENETRATION WITH CONCRETE. FULL FLOOR THICKNESS AND MAINTAIN FIRE-RESISTIVE RATING OF FLOOR SYSTEM. FINISH CONCRETE IN MANNER SUITABLE FOR NEW FLOOR FINISHES.
- X PATCH ALL WALL INTERSECTIONS AND PENETRATIONS RESULTING FROM THE REMOVAL OF EXISTING WALLS, DUCTWORK, PIPING ELECTRICAL RACEWAYS, ETC. IN THE INTERIOR WALLS TO REMAIN. THE PENETRATIONS SHALL BE FILLED FLUSHED WITH AND OF THE SAME MATERIALS AS THE SURROUNDING WALLS (INCLUDES WORK ABOVE CEILINGS).



Renovations to METS Garage and Transfer Terminal



Garage - 601 John St. Evansville, IN 47713  
Transfer Terminal - Sixth St. & Sycamore St. Evansville, IN 47630



In association with:

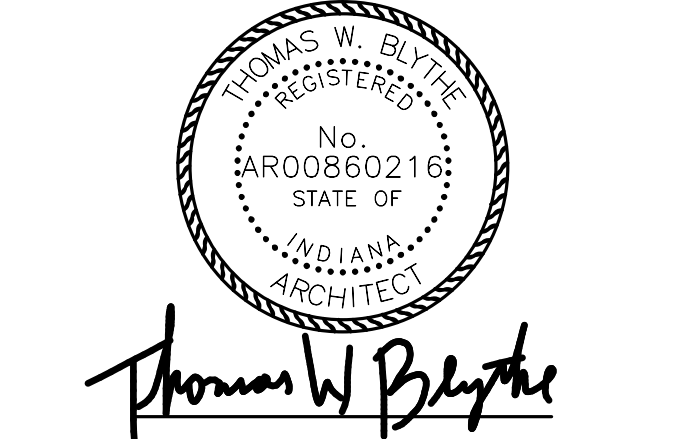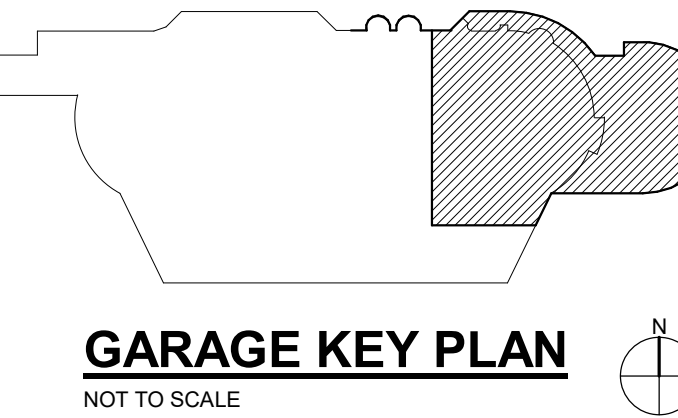

Revisions:		
#	Description	Date
1	ADD-001	2025/08/12

Designed By: Drawn By: Checked By:


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DEMOLITION PLAN - EAST AND NORTH

Architect's Project No: 2411-351 Date: August, 2025

Drawing No: D1.2



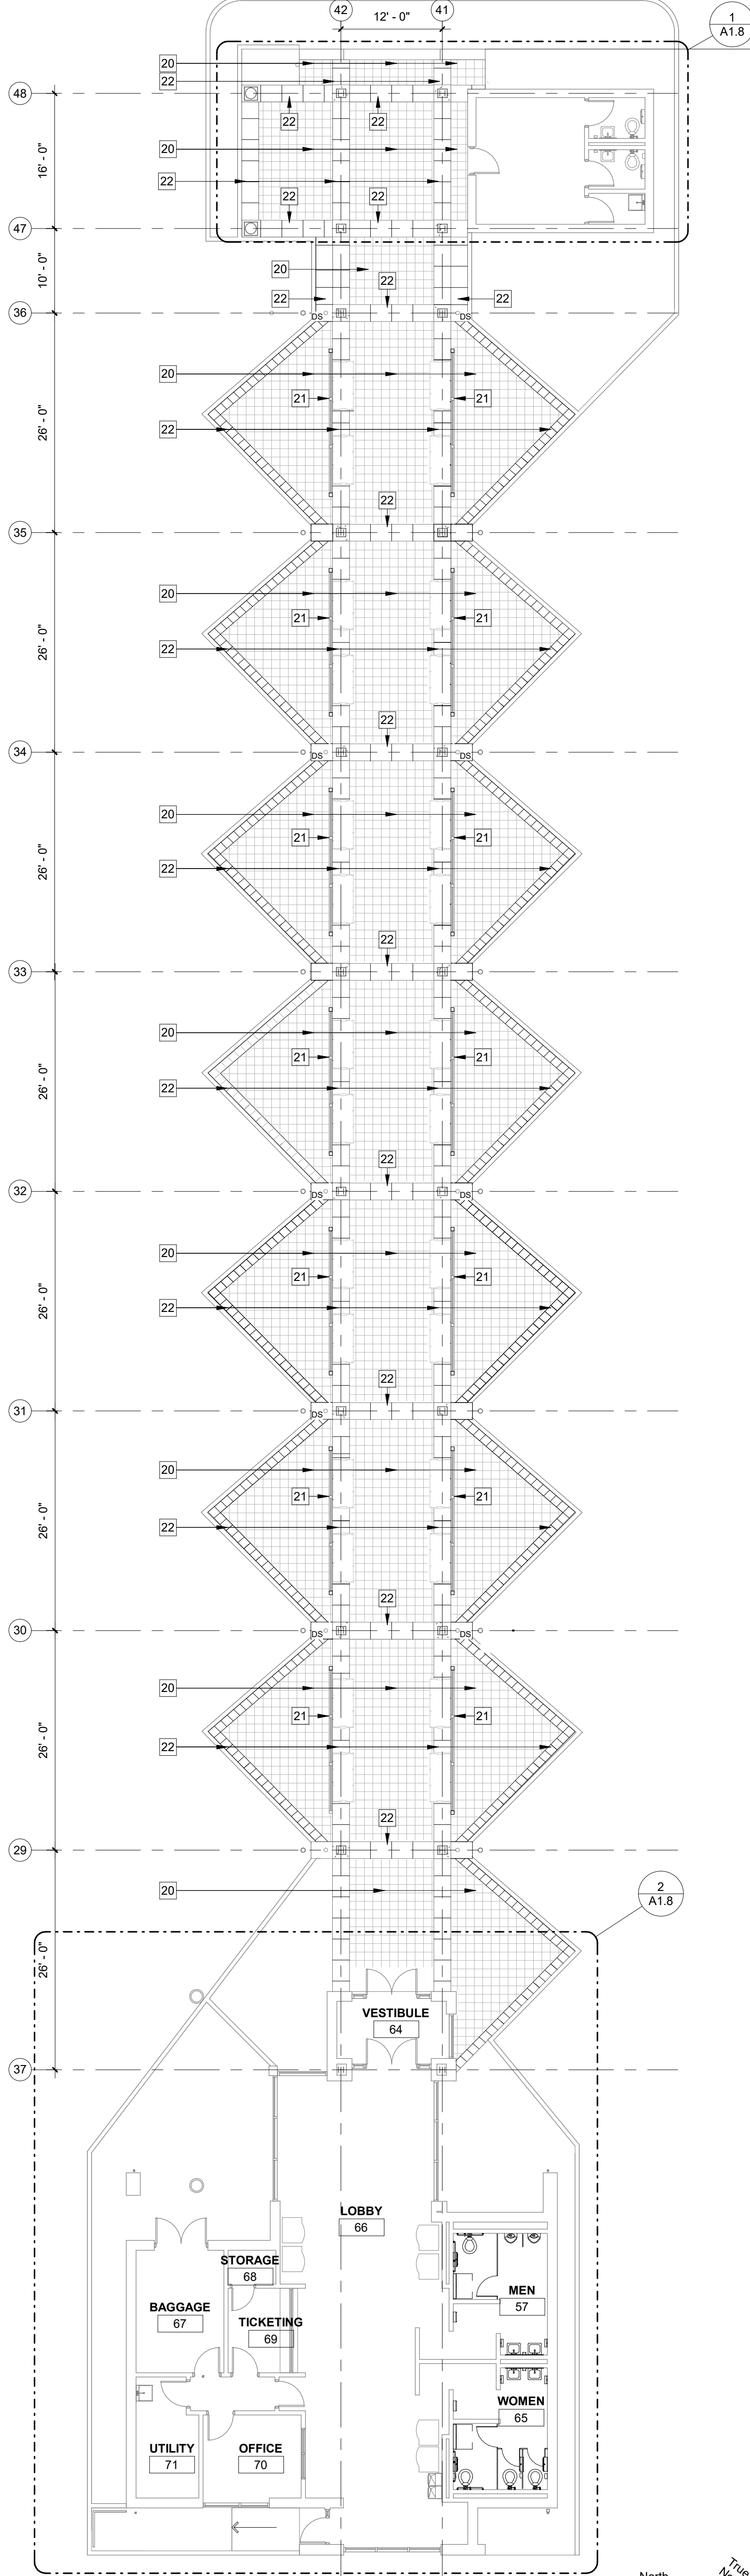

**FLOOR PLAN - TRANSFER TERMINAL**  
3/32" = 1'-0"

**ROOF PLAN REFERENCE NOTES:**

- 1 EXISTING BRICK PAVERS
- 2 EXISTING STONE COPING TO REMAIN , CLEANED AND RE CAULKED
- 3 EXISTING METAL RIDGE CAP
- 4 EXISTING METAL GUTTER
- 5 EXISTING METAL DOWNSPOUT
- 6 EXISTING STANDING SEAM METAL ROOFING
- 7 EXISTING ROOF TOP EQUIPMENT
- 8 EXISTING METAL FASCIA
- 9 EXISTING PLUMBING FIXTURE - REFER TO PLUMBING DRAWINGS


**ABBREVIATIONS:**

- DS - DOWNSPOUT  
EV - EXHAUST VENT  
EWC - ELECTRIC WATER COOLER  
VM - VENDING MACHINE

**FLOOR PLAN / ELEVATIONS REFERENCE NOTES:**

- 1 NEW METAL LOCKERS
- 2 PLUMBING FIXTURE - REFER TO PLUMBING DWGS.
- 3 NEW PLASTIC LAMINATE COUNTERTOP W/ BACKSPLASH
- 4 SCHEDULED BASE
- 5 CONCRETE LOCKER BASE W/ APPLIED SCHEDULED BASE
- 6 SLOPED TOP - TO MATCH LOCKERS
- 7 METAL FILLER PANEL - TO MATCH LOCKERS
- 8 NEW WALL - 3 5/8" METAL STUD FRAMING @ 16" O.C. MAX. & 1 LAYER 5/8" GYPSUM BOARD.
- 9 REFRIGERATOR - OFCI
- 10 WOOD BENCH
- 11 EXISTING BOLLARD TO REMAIN AND BE PAINTED
- 12 EXISTING STEEL GUARDRAIL AND POSTS TO REMAIN AND BE PAINTED
- 13 EXISTING FLOOR STRIPING TO BE REPAINTED
- 14 EXISTING STEEL COLUMN TO BE PAINTED
- 15 EXISTING TRENCH DRAIN
- 16 EXISTING STEEL PIPE GUARDRAIL / HANDRAIL TO REMAIN AND BE PAINTED
- 17 EXISTING WOOD BASE CABINET
- 18 NEW WALL - 3 5/8" METAL STUD FRAMING @ 16" O.C. MAX. W/ 1 LAYER 5/8" GYPSUM BOARD, EACH SIDE.
- 19 NEW DOOR INSTALLED IN EXISTING FRAME. FRAME TO BE PAINTED
- 20 ALL CRACKED, CHIPPED, OR DEPRESSED AREAS AT EXISTING BRICK PAVERS SHALL BE PATCHED, SEALED & FINISHED. TO MATCH ADJACENT PAVERS. CONTRACTOR SHALL MEET WITH OWNER & ARCHITECT TO CONFIRM DAMAGED AREAS TO BE REPAIRED. PRIOR TO NEW WORK
- 21 WIND SCREEN REPAIR AND PAINTING. DAMAGED AREAS AT EXISTING METAL FRAME & POSTS. AT WIND SCREENS. SHALL BE REPAIRED. WELD, GRIND, PREP & PAINT (COLOR TO BE SELECTED BY ARCHITECT). ENTIRE FRAME & POSTS SHALL BE PAINTED. REPLACE SEVEN (7) GLASS PANELS WHICH HAVE BEEN BROKEN. PROVIDE NEW METAL FRAME AT BASE, WHERE EXISTING IS MISSING (6 - REQ'D.). PROVIDE METAL BASE FRAMING AT 5 AREAS, WHERE EXISTING IS MISSING. PROVIDE TWENTY (20) LIN. FT. OF GLASS. STOPS, WHERE EXISTING IS MISSING. PROVIDE TEN (10) LIN. FT. OF METAL PLATE FILLERS, TO MATCH FRAMING, WHERE EXISTING HOLES OCCUR.
- 22 EXISTING CONCRETE PAVING TO BE CLEANED

**2 ENLARGED FLOOR PLAN**  
1/4" = 1'-0"

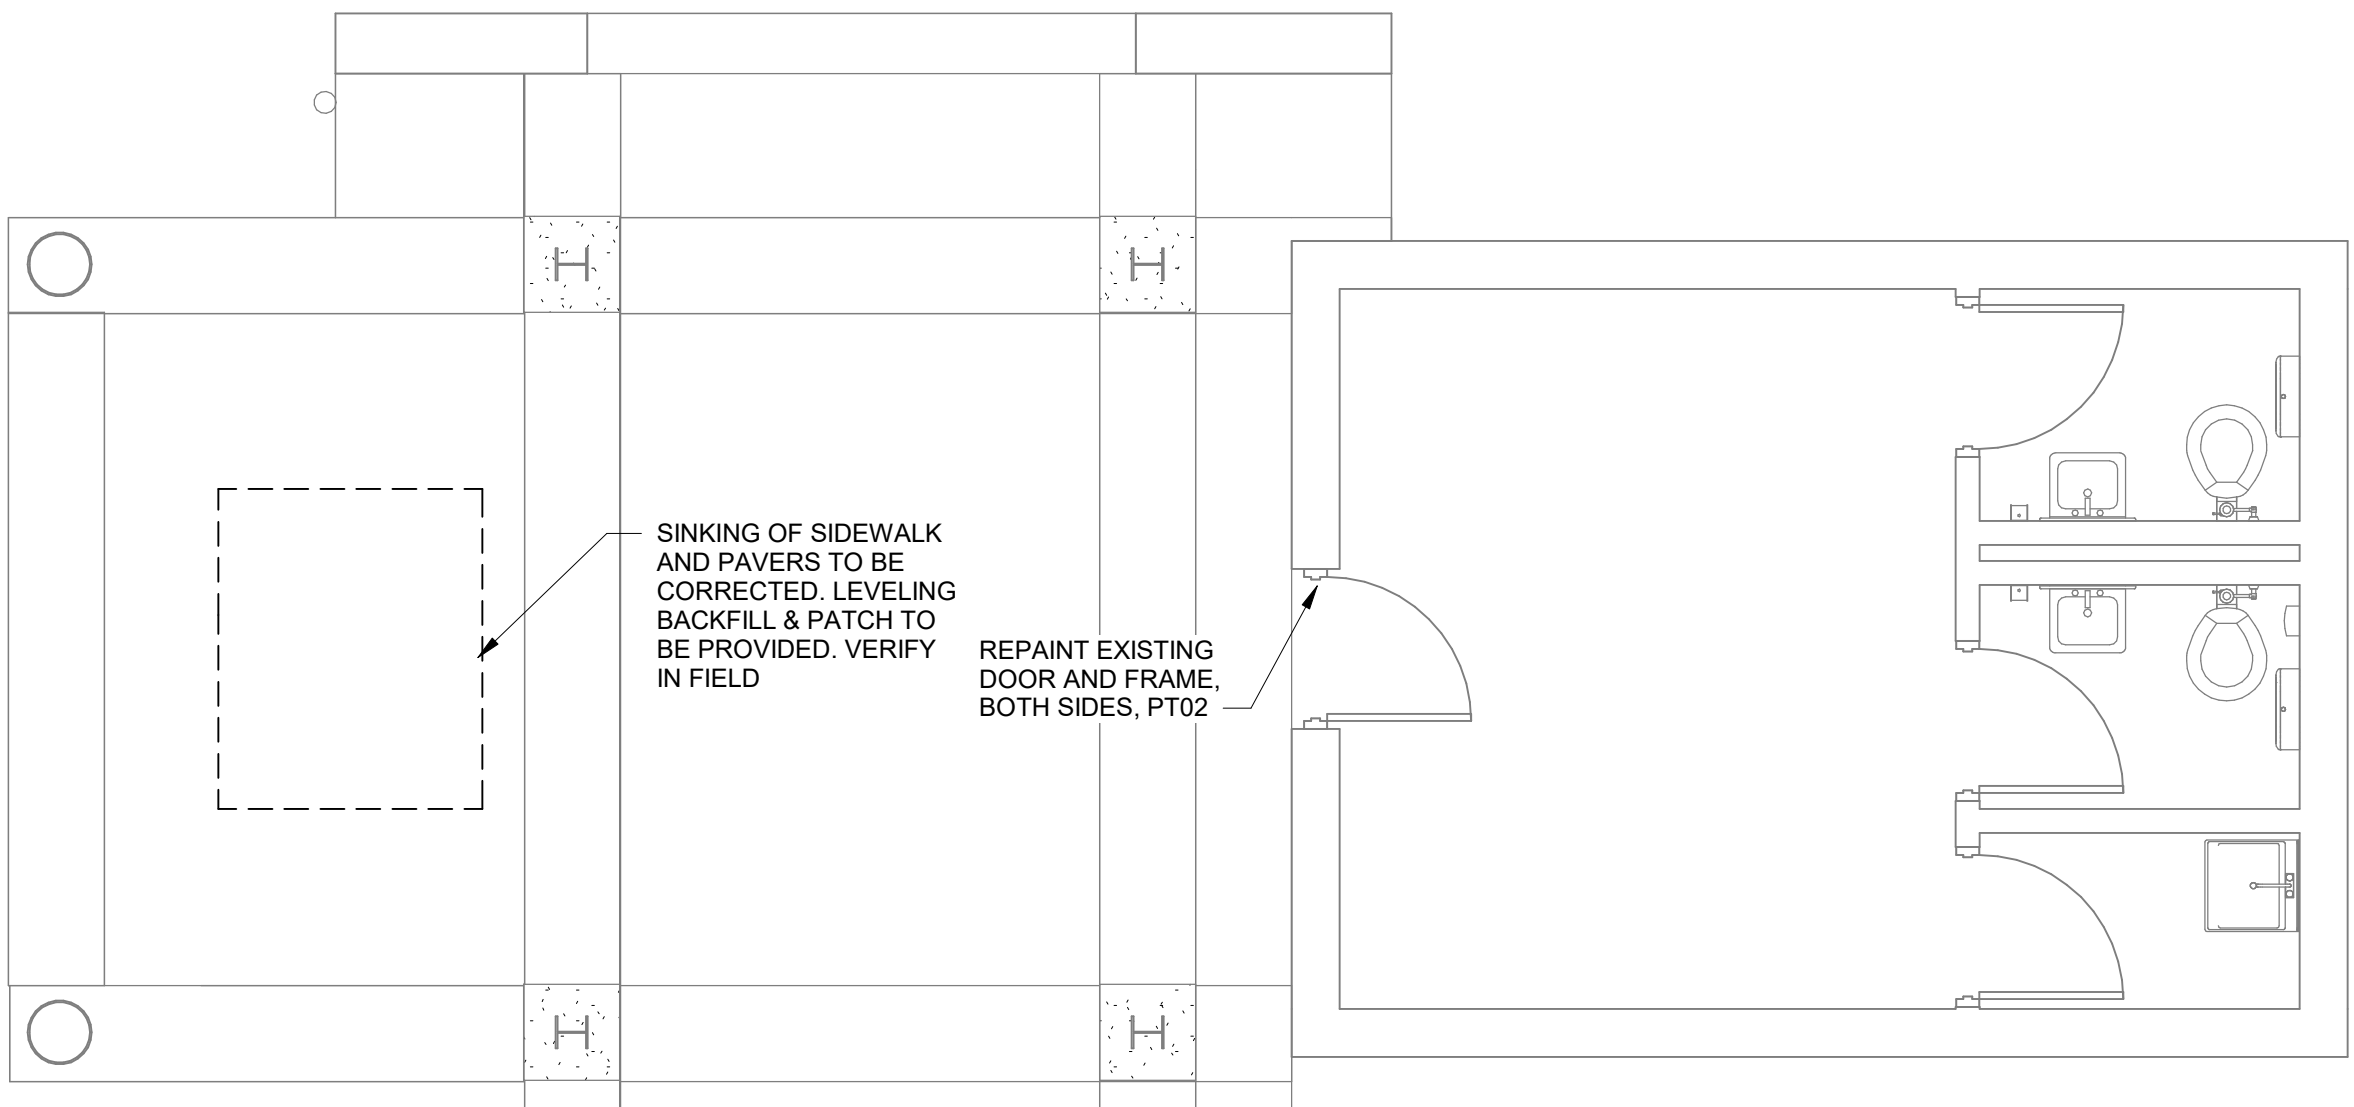

**1 ENLARGED FLOOR PLAN**  
1/4" = 1'-0"

**TOILET ACCESSORY SCHEDULE:**

MANUFACTURE MODEL NUMBERS REFER TO "BOBRICK WASHROOM ACCESSORIES," SATIN STAINLESS FINISH OR APPROVED EQUAL		
SYMBOL	ACCESSORY TYPE	DESCRIPTION
A	TOILET TISSUE DISPENSER	OFCI
B	SANITARY NAPKIN DISPOSAL	OFCI
C	GRAB BAR 36" HORIZONTAL (BACK) GRAB BAR 42" HORIZONTAL (SIDE) GRAB BAR 18" VERTICAL GRAB BAR 36" VERTICAL ( AT URINAL, RM. 25)	CFCI
F	18"x30" MIRROR GLASS	CFCI
G	24"x36" MIRROR GLASS	CFCI
H	PAPER TOWEL DISPENSER	OFCI
J	SOAP DISPENSER	OFCI
K	TOILET PARTITION	CFCI PHENOLIC CORE FLOOR MOUNTED AND OVERHEAD BRACED
L	ROBE HOOK	CFCI
M	BABY CHANGING STATION	CFCI
N	SEAT COVER DISPENSER	OFCI
O	URINAL SCREEN	CFCI PHENOLIC CORE WALL MOUNTED
P	PAPER TOWEL DISPENSER & DISPOSAL	CFCI

**ABBREVIATIONS:**

- CFCI CONTRACTOR FURNISHED  
CONTRACTOR INSTALLED  
OFCI OWNER FURNISHED  
CONTRACTOR INSTALLED  
OFOI OWNER FURNISHED  
OWNER INSTALLED

**Renovations to METS Garage  
and Transfer Terminal**





Garage - 601 John St.  
Evansville, IN 47713

Transfer Terminal - Sixth St. & Sycamore St.  
Evansville, IN 47630

**HAFER**  
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Suite 800  
Evansville, IN 47708  
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In association with:



#	Description	Date
1	ADD-001	2025/08/12

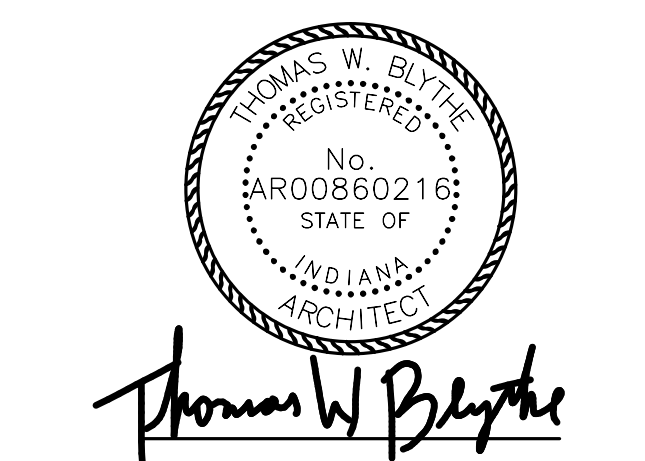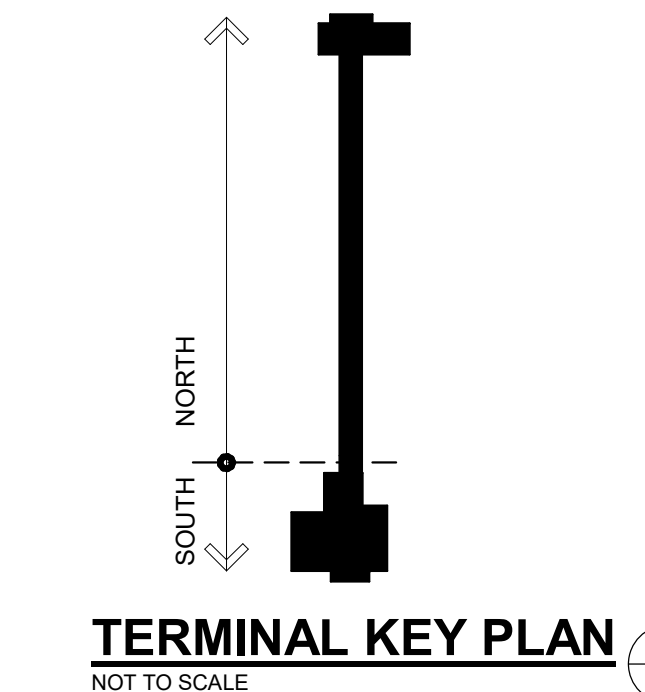Designed By: Drawn By: Checked By:

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**TRANSFER TERMINAL FLOOR PLANS**

Architect's Project No. Date:

2411-351 August, 2025


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**A1.8**





GARAGE ROOM FINISH SCHEDULE

Room		Floor Finish	Base Finish	Wall Finish				Ceiling Finish	Comments	Number
Number	Name			Wall A	Wall B	Wall C	Wall D			
2	SHOWER	ETR	ETR	PT01	PT01	PT01	PT01	PT04		2
3	SHOWER	ETR	ETR	PT01	PT01	PT01	PT01	PT04		3
4	MENS LOCKER ROOM	ETR	ETR	PT01/PT03	PT01/PT03	PT01	PT01/PT03	PT04		4
5	WOMENS LOCKER ROOM	ETR	ETR	PT01/PT03	PT01/PT03	PT01/PT03	PT01	PT04		5
6	VENDING AREA	ETR	ETR	PT01	PT01/PT02	PT01	PT01	PT04		6
7	OFFICE	ETR	ETR	PT02	PT02	PT01	PT01	PT04		7
8	MOBILITY DISPATCH	ETR	ETR	PT01	PT01	PT02	PT02	PT04		8
9	SUPPLIES	ETR	ETR	PT01	PT01	PT02	PT02	PT04		9
10	OFFICE	ETR	ETR	PT01	PT01/PT02	PT02	PT01/PT02	PT04		10
11	OFFICE	ETR	ETR	PT01	PT01	PT02	PT02	PT04		11
12	OFFICE	ETR	ETR	PT02	PT02	PT01	PT01	PT04		12
13	OFFICE	ETR	ETR	PT02	PT02	PT01	PT01	PT04		13
15	OPEN COURT	--	--	--	--	--	--	--	1, 3	15
16	MECHANICS OFFICE	RF01	RB01	PT02	PT02	PT02	PT02/PT03	--	3	16
18	BUS WASH	--	--	PT07 / PT08	PT07 / PT08	--	--	--	1, 3	18
19	BUS MARSHALLING AREA	--	--	PT07 / PT08	PT07 / PT08	--	--	--	1, 3	19
20	TURN AROUND	--	--	PT06 / PT07 / PT08	PT07 / PT08	PT07 / PT08	PT07 / PT08	--	1, 3	20
21	SERVICING	--	--	PT06 / PT07 / PT08	--	--	--	--	1, 3	21
22	VEST.	WO01	RB01	PT01	PT02	--	PT01	PT04		22
23	CONFERENCE ROOM	ETR / CPT01	ETR	PT02	PT01/SAW01/SAW02	PT01/SAW01/SAW02	PT02	PT04/PT03	3	23
24	COMMONS	ETR	ETR	PT01	PT01/SAW01/SAW03/SAW04/SAW05	PT01	PT01/PT02/SAW01/SAW02	PT04	2	24
25	MENS TOILET	ETR	ETR	PT01	PT02	PT01	PT01	PT04		25
26	WOMENS TOILET	ETR	ETR	PT02	PT01	PT01	PT01	PT04		26
27	COMPUTER EQUIPMENT	ETR	ETR	PT01	PT01	PT01	PT01	PT04		27
28	CORRIDOR	ETR	ETR	PT01	PT01	PT01	PT01	PT04	2	28
29	LOBBY	LVT01	RB01	PT01	PT02	PT01	PT01	PT04		29
30	OFFICE	ETR	ETR	PT02	PT01	PT01	PT01	PT04		30
31	FARE BOX REPAIR	LVT01	RB01	PT02	PT01	PT01	PT01	PT04	3.	31
32	TOILET	RF01	RF01	PT01	PT01	PT02	PT01	PT04		32
37	MAINTENANCE ISLAND	--	--	PT06 / PT07 / PT08	PT06 / PT07 / PT08	PT07 / PT08	PT07 / PT08	--	1, 3	37
38	TURN AROUND	--	--	PT08	PT06 / PT07 / PT08	PT07 / PT08	PT07 / PT08	--	1, 3	38
39	GARAGE	--	--	PT06 / PT07 / PT08	PT07 / PT08	--	--	--	1, 3	39
40	BUS PARKING	--	--	PT07 / PT08	PT07 / PT08	--	--	--	1, 3	40
46	MENS TOILET	ETR	ETR	PT01	PT01/PT03	PT03	PT01	PT04	3	46
47	WOMENS TOILET	ETR	ETR	PT01	PT01/PT03	PT01	PT03	PT04	3	47
48	JANITOR	ETR	ETR	PT01	PT01	PT01	PT01	PT04		48
49	RECEPTIONIST	ETR	ETR	PT01	PT02	PT01	PT01	PT04		49
50	CORRIDOR	ETR	ETR	PT01	PT01	PT01	PT01	PT04	2	50
51	CORRIDOR	ETR	ETR	PT01	PT01	PT01	PT01	PT04		51
52	DRIVERS LOUNGE	ETR	ETR	PT01	PT02	PT02 / GT01	PT01	PT04	2	52
58	VESTIBULE	WO01	RB01	ETR	ETR	ETR	ETR	PT04		58
59	NEW OFFICE	ETRLVT01	--	PT01	PT02	PT01	PT01	PT04		59

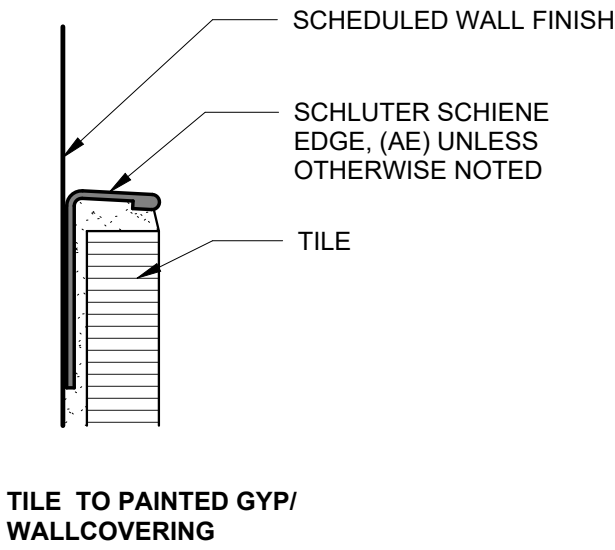

2 12" = 1'-0"

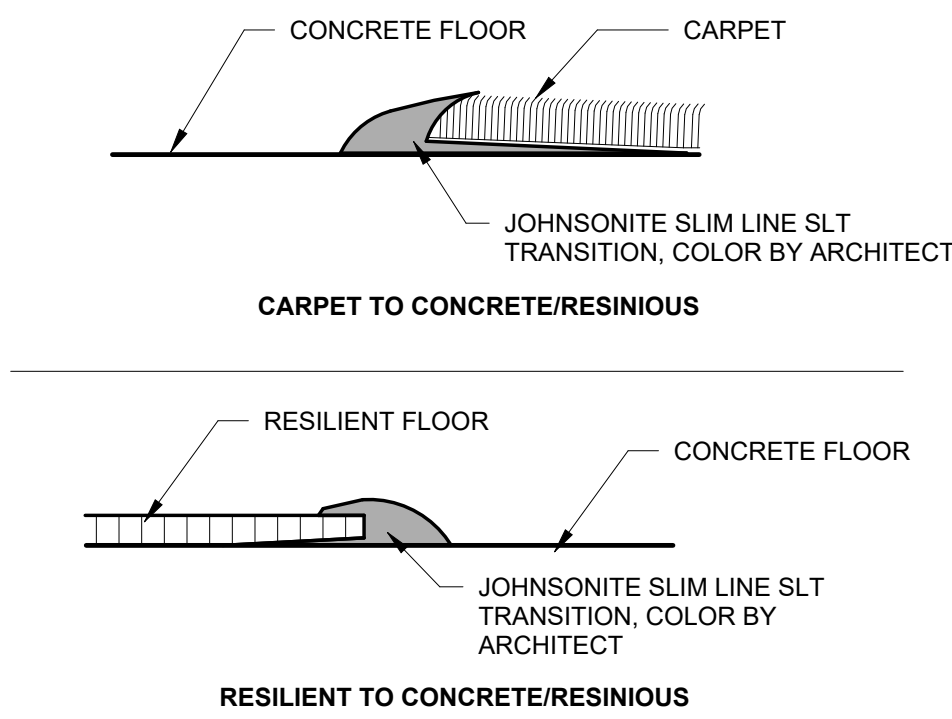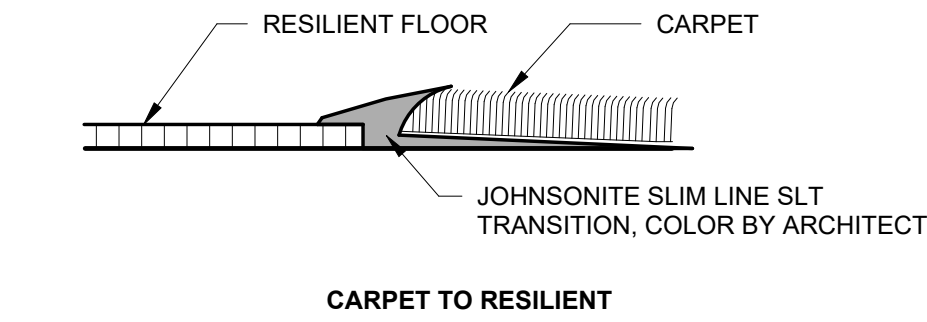

1 12" = 1'-0"

MATERIAL FINISH LEGEND

064116 PLASTIC-LAMINATE-CLAD ARCHITECTURAL CABINETS	
PL01 MFG: FORMICA COLOR: CITADEL WARP NMBR: SW 7015 FINISH: MATTE	PLASTIC LAMINATE
PL02 MFG: WILSONART COLOR: CLASSIC LINEN NMBR: 4843-38 FINISH: FINE VELVET	PLASTIC LAMINATE

093023 GLASS MOSAIC TILING	
GT01 MFG: ANTHOLOGY STYLE: MYSTIC GLASS FINISH: GLASS COLOR: WHIRLWIND MIX SIZE: 12" X 12" SHEET GROUT: TEC POWER GROUT GROUT COLOR: DOVE GRAY 908	GLASS MOSAIC TILE

096513 RESILIENT BASE AND ACCESSORIES	
RB01 MFG: JOHNSONITE STYLE: TRADITIONAL COVE HEIGHT: 4.5 COLOR: DARK BROWN #44	RUBBER WALL BASE

096519 RESILIENT TILE FLOORING	
LVT01 MFG: SHAW STYLE: GRAIN DIRECT GLUE COLOR: CLOVE NMBR: 64740 SIZE: 7" X 48" NOTE: USE OWNER ATTIC STOCK OF 839 SQ FT	LUXURY VINYL TILE FLOORING

096723 RESINOUS FLOORING	
RF01 MFG: SHERWIN WILLIAMS COLCT: RESULFJLOR DECO QUARTZ BC23 COLOR: MIDNIGHT TOP COAT: EPOXY BASE HEIGHT: 8" BASE CAP: ALUMINUM	RESINOUS FLOORING

097200 WALL COVERINGS	
WC01 NOTE: OWNER PROVIDED, OWNER INSTALLED WALL GRAPHIC. NO WORK REQUIRED BY G.C.	WALL COVERINGS
WC02 NOTE: OWNER PROVIDED, OWNER INSTALLED WALL GRAPHIC. NO WORK REQUIRED BY G.C.	WALL COVERINGS
WC03 NOTE: OWNER PROVIDED, OWNER INSTALLED WALL GRAPHIC. NO WORK REQUIRED BY G.C.	WALL COVERINGS

098433 SOUND-ABSORBING WALL UNITS	
SAW01 MFG: ZINTRA STYLE: PLAIN TILES RECTANGLE EDGE STYLE: SQUARE COLOR: GREIGE SIZE: 47.24" X 23.62" MOUNTING: DIRECT ADHERED	SOUND-ABSORBING WALL UNITS
SAW02 MFG: ZINTRA STYLE: PLAIN TILES RECTANGLE EDGE STYLE: SQUARE COLOR: GRASS SIZE: 47.24" X 23.62" MOUNTING: DIRECT ADHERED	SOUND-ABSORBING WALL UNITS
SAW03 MFG: ZINTRA STYLE: PLAIN TILES PARALLELOGRAM EDGE STYLE: SQUARE COLOR: COBALT SIZE: 23.62" W X 47.24" H MOUNTING: DIRECT ADHERED	SOUND-ABSORBING WALL UNITS
SAW04 MFG: ZINTRA STYLE: PLAIN TILES PARALLELOGRAM EDGE STYLE: SQUARE COLOR: SKY SIZE: 23.62" W X 47.24" H MOUNTING: DIRECT ADHERED	SOUND-ABSORBING WALL UNITS
SAW05 MFG: ZINTRA STYLE: PLAIN TILES PARALLELOGRAM EDGE STYLE: SQUARE COLOR: GRASS SIZE: 23.62" W X 47.24" H MOUNTING: DIRECT ADHERED	SOUND-ABSORBING WALL UNITS

MATERIAL FINISH LEGEND

099123 INTERIOR PAINTING	
PT01 MFG: SHERWIN WILLIAMS COLOR: REPOSE GRAY NMBR: SW 7015	FIELD PAINT
PT02 MFG: SHERWIN WILLIAMS COLOR: DORIAN GRAY NMBR: SW 7017	NEUTRAL ACCENT PAINT
PT03 MFG: PGS COLOR: TEENY BIKINI NMBR: PPG1162-6	BLUE ACCENT PAINT
PT04 MFG: SHERWIN WILLIAMS COLOR: CEILING BRIGHT WHITE NMBR: SW 7007	CEILING PAINT
PT05 MFG: SHERWIN WILLIAMS COLOR: DORIAN GRAY NMBR: SW 7017	DOOR & FRAME PAINT
PT06 MFG: SHERWIN WILLIAMS COLOR: LOGOGIA NMBR: SW 7506	GARAGE PAINT
PT07 MFG: PGS COLOR: GREEN PEAR NMBR: PPG1124-7	GREEN GARAGE PAINT
PT08 MFG: SHERWIN WILLIAMS COLOR: SAFETY YELLOW NMBR: SW 4084	SAFETY YELLOW PAINT

102113.13 METAL TOILET COMPARTMENTS	
MC01 MFG: GENERAL PARTITIONS SERIES: 40 FLOOR SUPPORTED COLOR: ADMIRAL BLUE	METAL TOILET COMPARTMENTS (TERMINAL)

102113.17 PHENOLIC-CORE TOILET COMPARTMENTS	
HCM01 MFG: GENERAL PARTITIONS SERIES: 40 FLOOR MOUNTED COLOR: PEWTER MESH 4878-60 PRIVACY: EASTERN STYLE W/ CONTINUOUS BRACKETS	PHENOLIC-CORE TOILET COMPARTMENTS (GARAGE)

105113 METAL LOCKERS	
ML01 MFG: HADRIAN STYLE: EMPEROR METAL LOCKERS TIERS: DOUBLE SIZE: 12"W x 12"D x 72"H COLOR: SAPPHIRE BLUE VENT: LOUVERS NOTE: PROVIDE 4" HIGH SLOPED TOP, MOUNTED ON CONCRETE BASE, INCLUDE INTERCHANGABLE NAME TAGS.	METAL LOCKERS
ML02 MFG: HADRIAN STYLE: EMPEROR METAL LOCKERS TIERS: SINGLE SIZE: 12"W x 12"D x 72"H COLOR: SAPPHIRE BLUE VENT: LOUVERS NOTE: PROVIDE 4" HIGH SLOPED TOP, MOUNTED ON CONCRETE BASE, INCLUDE INTERCHANGABLE NAME TAGS.	METAL LOCKERS
ML03 MFG: HADRIAN STYLE: EMPEROR METAL LOCKERS TIERS: SINGLE SIZE: 15"W x 15"D x 72"H COLOR: SAPPHIRE BLUE VENT: LOUVERS NOTE: PROVIDE 5" HIGH SLOPED TOP AND 3-1/2" HIGH BOX BASE FOR ALL LOCKERS	METAL LOCKERS

122413 ROLLER WINDOW SHADES	
RWS01 MFG: DRAPER SERIES: CLUTCH OPERATED FLEXSHADE STYLE: MANUAL ROLLER SHADE FABRIC SERIES: SHEERWEAVE SW2900 FABRIC % OPEN: 5% FABRIC COLOR: BEIGE/PEARL GRAY Q21 FASCIA SHAPE: SQUARE FASCIA COLOR: TBD NOTE: SEE ALTERNATE 2 FOR SCOPE	ROLLER WINDOW SHADES
RWS02 MFG: DRAPER SERIES: CLUTCH OPERATED FLEXSHADE STYLE: MANUAL ROLLER SHADE FABRIC SERIES: SHEERWEAVE SW2500 FABRIC % OPEN: 1% FABRIC COLOR: BEIGE/PEARL GRAY Q21 FASCIA SHAPE: SQUARE FASCIA COLOR: TBD	ROLLER WINDOW SHADES

123661.16 SOLID SURFACING COUNTERTOPS	
SS01 MFG: DURASEIN COLOR: CONCRETE NMBR: DM3018	SOLID SURFACE

GENERAL INTERIOR FINISH NOTES

- ALL INTERIORS NOTES, SCHEDULES AND LEGENDS. REFERENCE ALSO LEGEND. REFER TO VIEW HEADER OF ROOM FINISH SCHEDULE.
- PROVIDE RESILIENT OR METAL TRANSITION STRIP AT ALL FLOORING MATERIAL JUNCTURES. WHERE MATERIALS TRANSITION AT DOORS CENTER OF TRANSITION TO BE LOCATED ON CENTER OF DOOR. REFER TO DETAILS FOR TYPICAL FLOOR MATERIAL TRANSITIONS. COLOR SELECTED BY ARCHITECT FROM MANUFACTURES FULL RANGE OF COLORS.
- ALL EXPOSED GYP. CEILINGS AS WELL AS UNDERSIDE AND FACES OF BULKHEADS, AND SOFFITS TO BE PAINTED. REFER TO FINISH SCHEDULE FOR CEILING FINISHES AND REFLECTED CEILING PLANS FOR CEILING MATERIAL EXTENTS AND FINISH REQUIREMENTS. COORDINATE ANY PAINT FINISHES WITH ARCHITECT IN FIELD BEFORE PROCEEDING WITH FINISH WORK.
- REFER TO DOOR SCHEDULE FOR CLARIFICATION OF DOOR MATERIALS. ALL HOLLOW METAL DOORS AND HOLLOW METAL FRAMES TO BE PAINTED BOTH SIDES, PT02.
- ALL EXPOSED GYP WALLS TO BE PAINTED UNLESS NOTED OTHERWISE.
- ALL DIFFUSERS TO BE PAINTED TO MATCH ADJACENT WALL FINISH. VERIFY COLOR WITH ARCHITECT IN FIELD.
- PAINT FINISH SHEEN SCHEDULE: WALLS - EGGSHELL ACRYLIC LATEX, HOLLOW METAL DOORS AND FRAMES - SEMI GLOSS WATERBASED ALKYD URETHANE ENAMEL; CEILING - FLAT ACRYLIC LATEX, RESTROOM - EGGSHELL EPOXY; UNLESS NOTED OTHERWISE.
- WINDOW SILLS TO BE PLASTIC LAMINATE, PL02, SCOPE NOTED ON ARCHITECTURAL PLAN AND ELEVATIONS, NOTE 36.
- REFER TO FINISH FLOOR PLANS FOR PAINT ACCENT LOCATIONS AND FLOOR FINISH PATTERNS AND EXTENTS.
- REFER TO INTERIOR ELEVATIONS FOR CASEWORK FINISH LOCATION.
- WHERE NEW FINISHES WOULD MATCH EXISTING FINISHES, OR NEW FINISHES ARE NOT REQUIRED, MAINTAIN EXISTING FINISHES WHERE POSSIBLE DURING DEMOLITION AND CONSTRUCTION PHASE FOR REUSE. PATCH AND MATCH EXISTING FINISHES WHERE DISTURBED BY CONSTRUCTION.
- CONFIRM ACCENT PAINT LOCATION AND COLOR WITH ARCHITECT IN FIELD BEFORE PROCEEDING WITH FINISH WORK.
- WHERE NEW FINISHES REQUIRE DEMOLITION OF EXISTING FINISHES, COMPLETE ALL DEMOLITION PRIOR TO INSTALLATION OF NEW FINISHES.
- PAINT ALL EXPOSED STEEL STRUCTURAL MEMBERS UNLESS NOTED OTHERWISE. COLOR(S) SELECTED BY ARCHITECT FROM FULL RANGE OF SHERWIN WILLIAMS COLORS.
- PAINT EXPOSED CEILINGS INCLUDING BUT NOT LIMITED TO BEAMS, WEBBING, METAL DECKING, PIPING, CONDUIT, UNISTRUT, HANGER RODS, WIRES, HVAC EQUIPMENT, HVAC GRILLES AND DIFFUSERS, AND ANY EXPOSED BUILDING INFRASTRUCTURE. PAINT ALL VISIBLE SUSPENSIONS AND SUPPORTS INCLUDING VISIBLE AREAS ABOVE ENCLOSED CEILINGS. THIS INCLUDES ANY ITEMS INSTALLED IN CEILING UP TO SUBSTANTIAL COMPLETION. PROTECT FROM PAINTING ANY ITEM PROHIBITED FROM BEING PAINTED INCLUDING BUT NOT LIMITED TO SPRINKLER HEADS, OUTLETS, EXPOSED CABLING, VALVES, GAUGES, CERTAIN SPEAKER COVERS ETC. PRIOR TO PAINTING BRING TO ARCHITECT'S ATTENTION ANY ISSUES OR CONCERNS WITH ITEMS TO BE PAINTED.

ROOM FINISH SCHEDULE  
COMMENTS:

- PAINT ALL VERTICAL SUPPORT BEAMS PT01, ALL EXPOSED SIDES, STOP AT HORIZONTAL BEAM AT TOP OF VERTICAL BEAM.
- USE SEMI-GLOSS PAINT IN THIS AREA.
- SEE ALTERNATES FOR SCOPE OF WORK.

Renovations to METS Garage  
and Transfer Terminal




Garage -  
601 John St.  
Evansville, IN  
47713

Transfer Terminal -  
Sixth St. & Sycamore St.  
Evansville, IN  
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In association with:



Thomas W Blythe

Revisions:
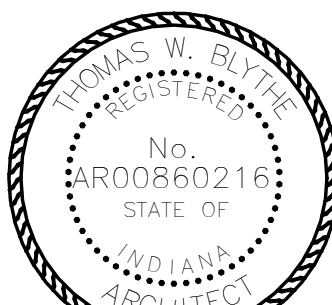
#	Description	Date
1	ADD-001	2025/09/12

Designed By:

Drawn By:

Checked By:

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Sheet title:

GARAGE FINISH LEGEND  
AND SCHEDULE

Architect's Project No:

Date:

2411-351

August, 2025



Drawing No:

ID1.0



FINISH FLOOR PLAN - WEST

1/8" = 1'-0"

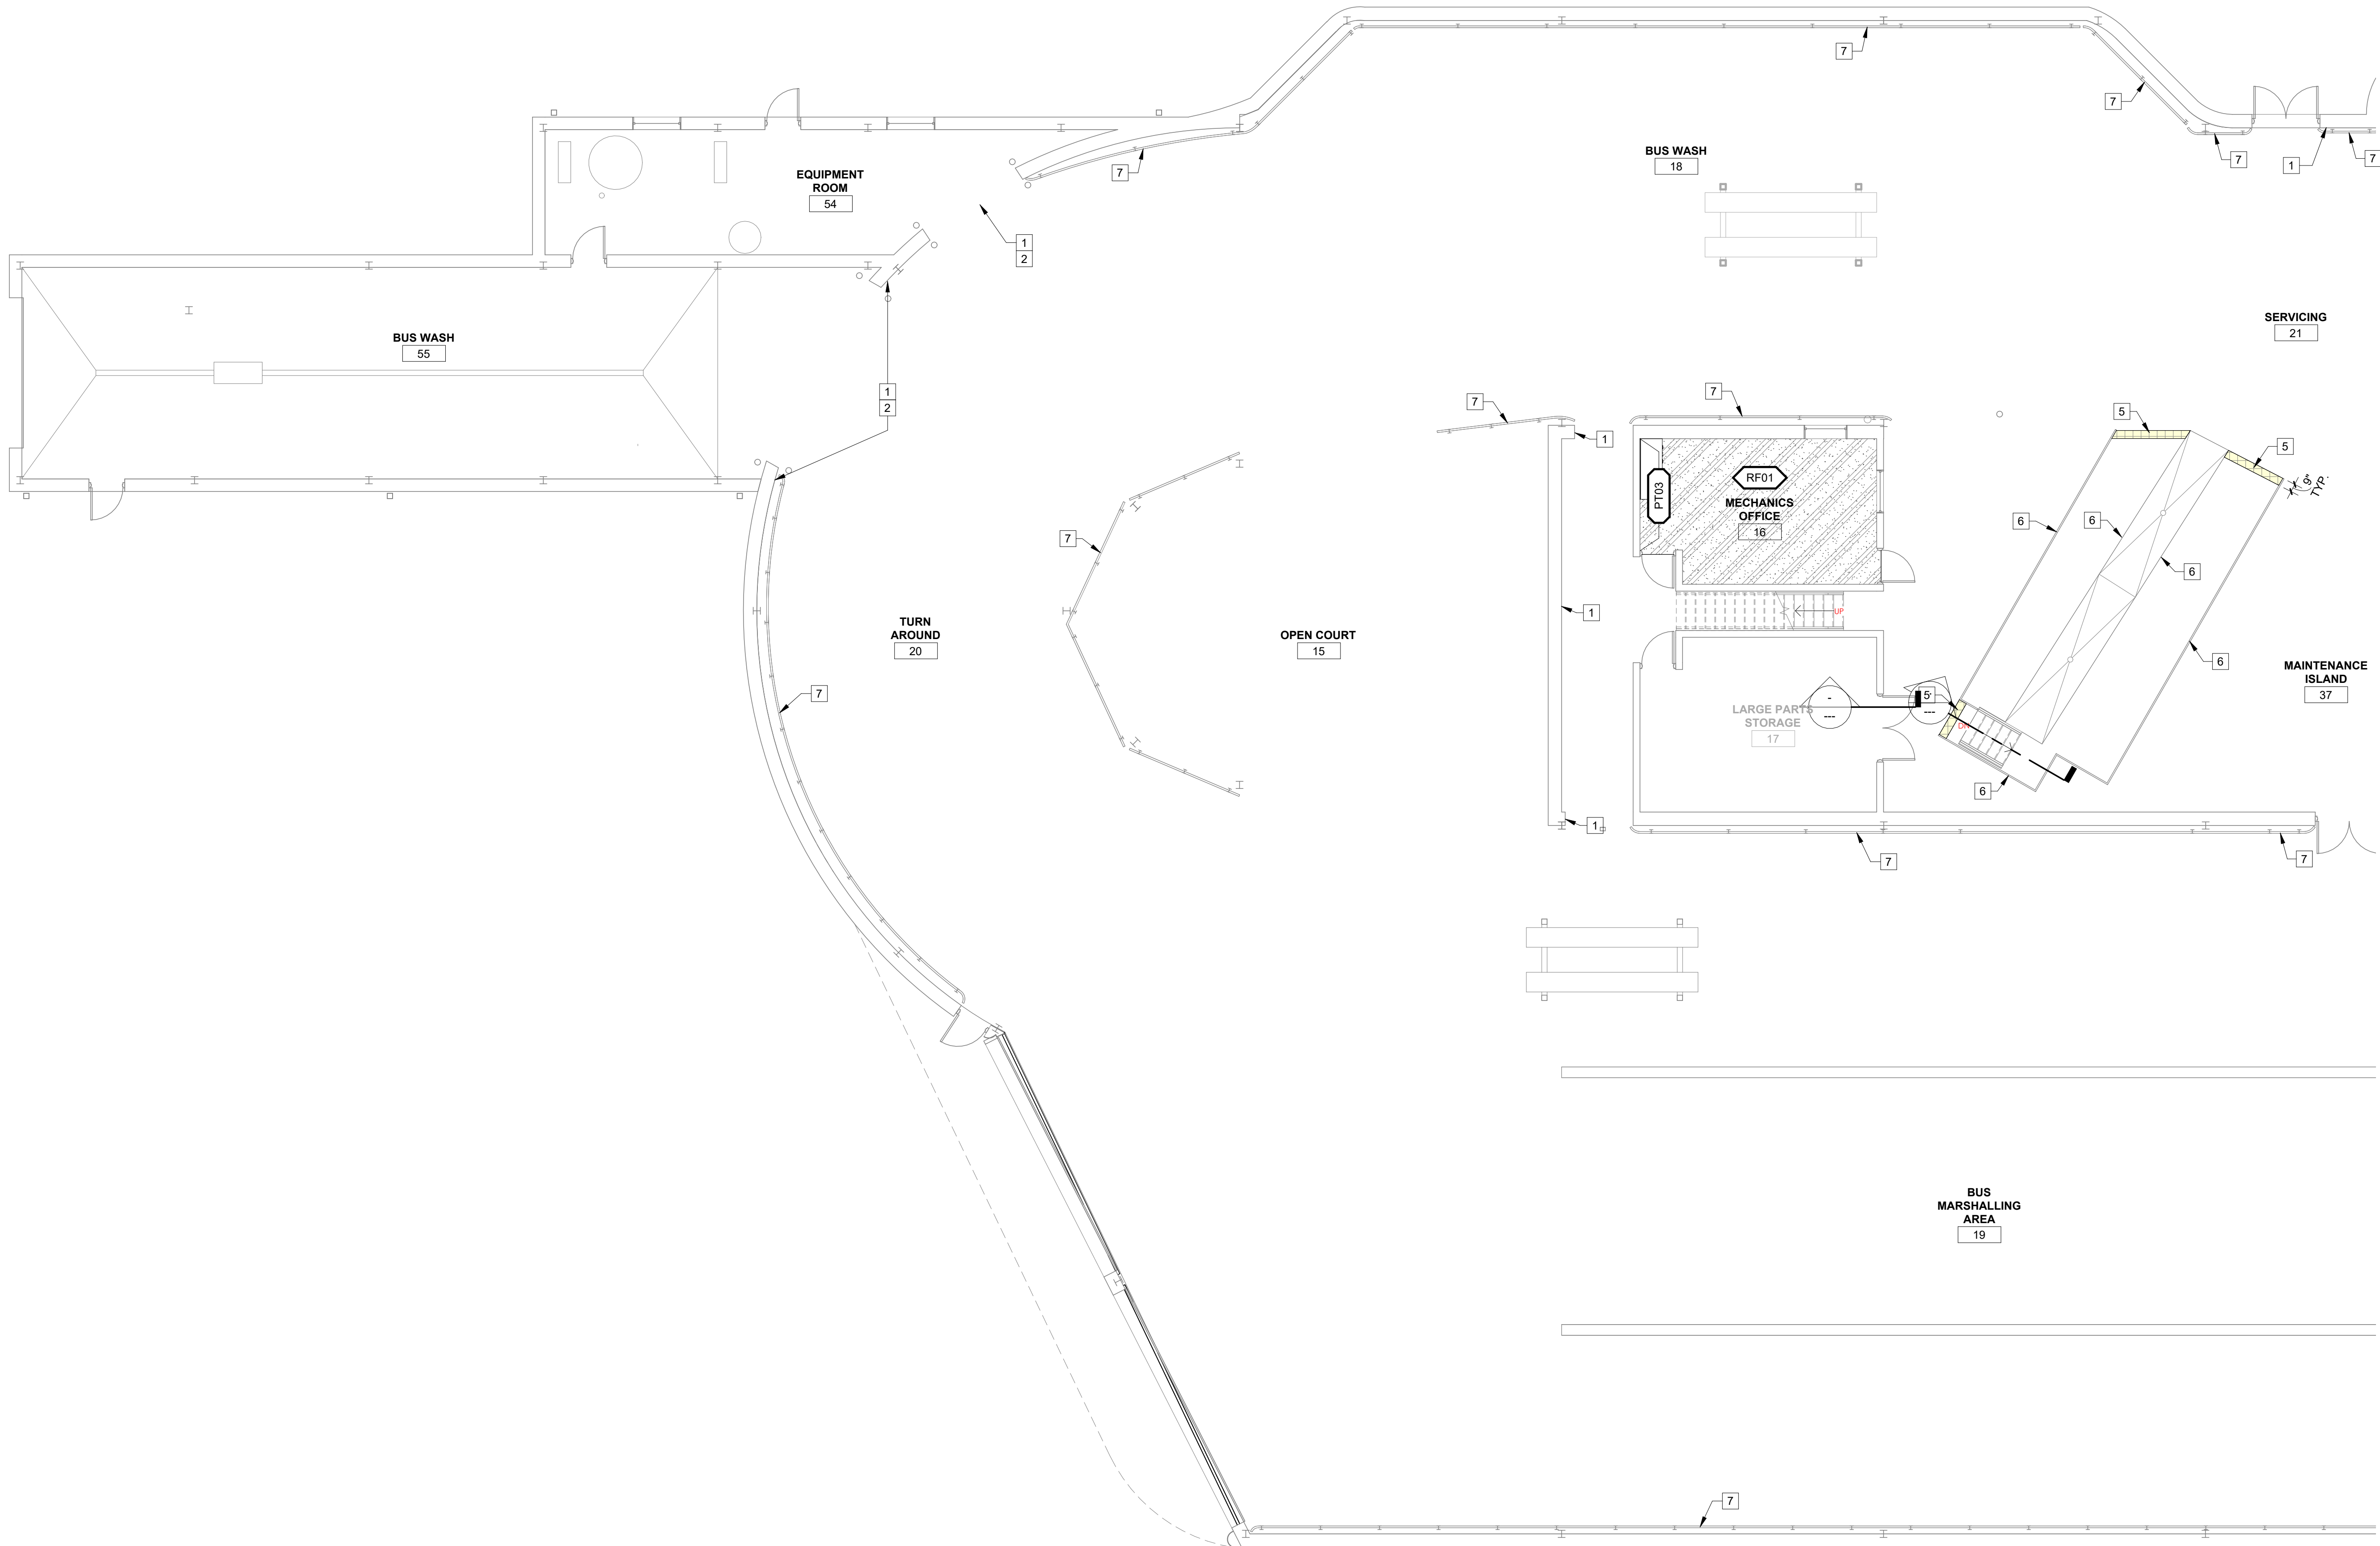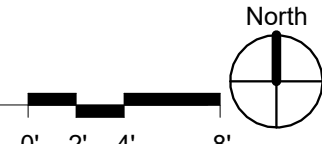

GENERAL INTERIOR FINISH NOTES

- A. ALL INTERIORS NOTES, SCHEDULES AND LEGENDS REFERENCE ABCD LEGEND. REFER TO VIEW HEADER OF ROOM FINISH SCHEDULE.
- B. PROVIDE RESILIENT OR METAL TRANSITION STRIP AT ALL FLOORING MATERIAL JUNCTURES. WHERE MATERIALS TRANSITION AT DOORS CENTER OF TRANSITION TO BE LOCATED ON CENTER OF DOOR. REFER TO DETAILS FOR TYPICAL FLOOR MATERIAL TRANSITIONS. COLOR SELECTED BY ARCHITECT FROM MANUFACTURES FULL RANGE OF COLORS.
- C. ALL EXPOSED GYP. CEILINGS AS WELL AS UNDERSIDE AND FACES OF BULKHEADS, AND SOFFITS TO BE PAINTED. REFER TO FINISH SCHEDULE FOR CEILING FINISHES AND REFLECTED CEILING PLANS FOR CEILING MATERIAL, EXTENTS AND FINISH REQUIREMENTS. COORDINATE ANY PAINT FINISHES WITH ARCHITECT IN FIELD BEFORE PROCEEDING WITH FINISH WORK.
- D. REFER TO DOOR SCHEDULE FOR CLARIFICATION OF DOOR MATERIALS. ALL HOLLOW METAL DOORS AND HOLLOW METAL FRAMES TO BE PAINTED BOTH SIDES, PT02.
- E. ALL EXPOSED GYP WALLS TO BE PAINTED UNLESS NOTED OTHERWISE.
- F. ALL DIFFUSERS TO BE PAINTED TO MATCH ADJACENT WALL FINISH. VERIFY COLOR WITH ARCHITECT IN FIELD.
- G. PAINT FINISH SHEEN SCHEDULE: WALLS - EGGSHELL ACRYLIC LATEX; HOLLOW METAL DOORS AND FRAMES - SEMI GLOSS WATERBASED ALKYD URETHANE ENAMEL; CEILING - FLAT ACRYLIC LATEX; RESTROOM - EGGSHELL EPOXY; UNLESS NOTED OTHERWISE.
- H. WINDOW SILLS TO BE PLASTIC LAMINATE, PL02, SCOPE NOTED ON ARCHITECTUAL PLAN AND ELEVATIONS, NOTE 36.
- I. REFER TO FINISH FLOOR PLANS FOR PAINT ACCENT LOCATIONS AND FLOOR FINISH PATTERNS AND EXTENTS.
- J. REFER TO INTERIOR ELEVATIONS FOR CASEWORK FINISH LOCATION.
- K. WHERE NEW FINISHES WOULD MATCH EXISTING FINISHES, OR NEW FINISHES ARE NOT REQUIRED, MAINTAIN EXISTING FINISHES WHERE POSSIBLE DURING DEMOLITION AND CONSTRUCTION PHASE FOR REUSE. PATCH AND MATCH EXISTING FINISHES WHERE DISTURBED BY CONSTRUCTION.
- L. CONFIRM ACCENT PAINT LOCATION AND COLOR WITH ARCHITECT IN FIELD BEFORE PROCEEDING WITH FINISH WORK.
- M. WHERE NEW FINISHES REQUIRE DEMOLITION OF EXISTING FINISHES, COMPLETE ALL DEMOLITION PRIOR TO INSTALLATION OF NEW FINISHES.
- N. PAINT ALL EXPOSED STEEL STRUCTURAL MEMBERS UNLESS NOTED OTHERWISE, COLOR(S) SELECTED BY ARCHITECT FROM FULL RANGE OF SHERWIN WILLIAMS COLORS.
- P. PAINT EXPOSED CEILINGS INCLUDING BUT NOT LIMITED TO BEAMS, WEBBING, METAL DECKING, PIPING, CONDUIT, UNISTRUT, HANGER RODS, WIRES, HVAC EQUIPMENT, HVAC GRILLES AND DIFFUSERS, AND ANY EXPOSED BUILDING INFRASTRUCTURE. PAINT ALL VISIBLE SUSPENSIONS AND SUPPORTS INCLUDING VISIBLE AREAS ABOVE ENCLOSED CEILINGS. THIS INCLUDES ANY ITEMS INSTALLED IN CEILING UP TO SUBSTANTIAL COMPLETION. PROTECT FROM PAINTING ANY ITEM PROHIBITED FROM BEING PAINTED INCLUDING BUT NOT LIMITED TO SPRINKLER HEADS, OUTLETS, EXPOSED CABLING, VALVES, GAUGES, CERTAIN SPEAKER COVERS ETC. PRIOR TO PAINTING BRING TO ARCHITECT'S ATTENTION ANY ISSUES OR CONCERNS WITH ITEMS TO BE PAINTED.

FINISH PLAN REFERENCE NOTES:

- 1 ALTERNATE WORK: PAINT SECTION OF WALL TO MATCH ADJACENT COLOR, PT06, TO MINIMAL EXTENTS REQUIRED.
- 2 FINISH NOTE REFERENCES WORK REQUIRED ABOVE 10'-0" ELEVATION.
- 3 ALTERNATE WORK: CLEAN EXISTING FLOOR TILE AND GROUT.
- 4 NEW WINDOW SHADE, RWS01.
- 5 ALTERNATE WORK: SAFETY YELLOW VINYL FLOOR STRIPING.
- 6 ALTERNATE WORK: PAINT RAILING SAFETY YELLOW, PT08, REFERENCE A1.2 & A1.3 FOR SCOPE OF WORK.
- 7 ALTERNATE WORK: PAINT END CAPS OF GUARD RAILS SAFETY YELLOW, PT08, REFERENCE A1.2 & A1.3 FOR SCOPE OF WORK.
- 8 PATCH FLOORING WITH LVT01, REPLACE +/- 12 TILES.
- 9 ALTERNATE WORK: PAINT ALL EXPOSED SIDES OF DUCTWORK PT07.
- 10 NEW WINDOW SHADE, RWS02.
- 11 LATERAL FILE STORAGE, OWNER FURNISHED, OWNER INSTALLED.
- 12 REFERENCE ELEVATION FOR FINISHES.
- 13 BASE BID: EXISTING HORIZONTAL BLINDS TO REMAIN ALTERNATE: NEW RWS01.
- 14 ALTERNATE WORK: PATCH FLOORING TO MATCH EXISTING WHERE AFFECTED BY DEMOLITION/NEW CONSTRUCTION.


Renovations to METS Garage and Transfer Terminal



Garage - 601 John St. Evansville, IN 47713  
Transfer Terminal - Sixth St. & Sycamore St. Evansville, IN 47630



In association with:

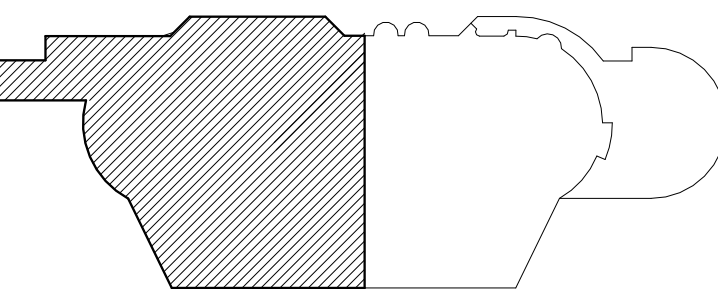

GARAGE KEY PLAN

NOT TO SCALE



Thomas W. Blythe

Revisions:

#	Description	Date
1	ADD-001	2025/09/12

Designed By: Drawn By: Checked By:

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Sheet title:

GARAGE FINISH PLAN WEST


Architect's Project No: Date:

2411-351 August, 2025

Drawing No:

ID1.1



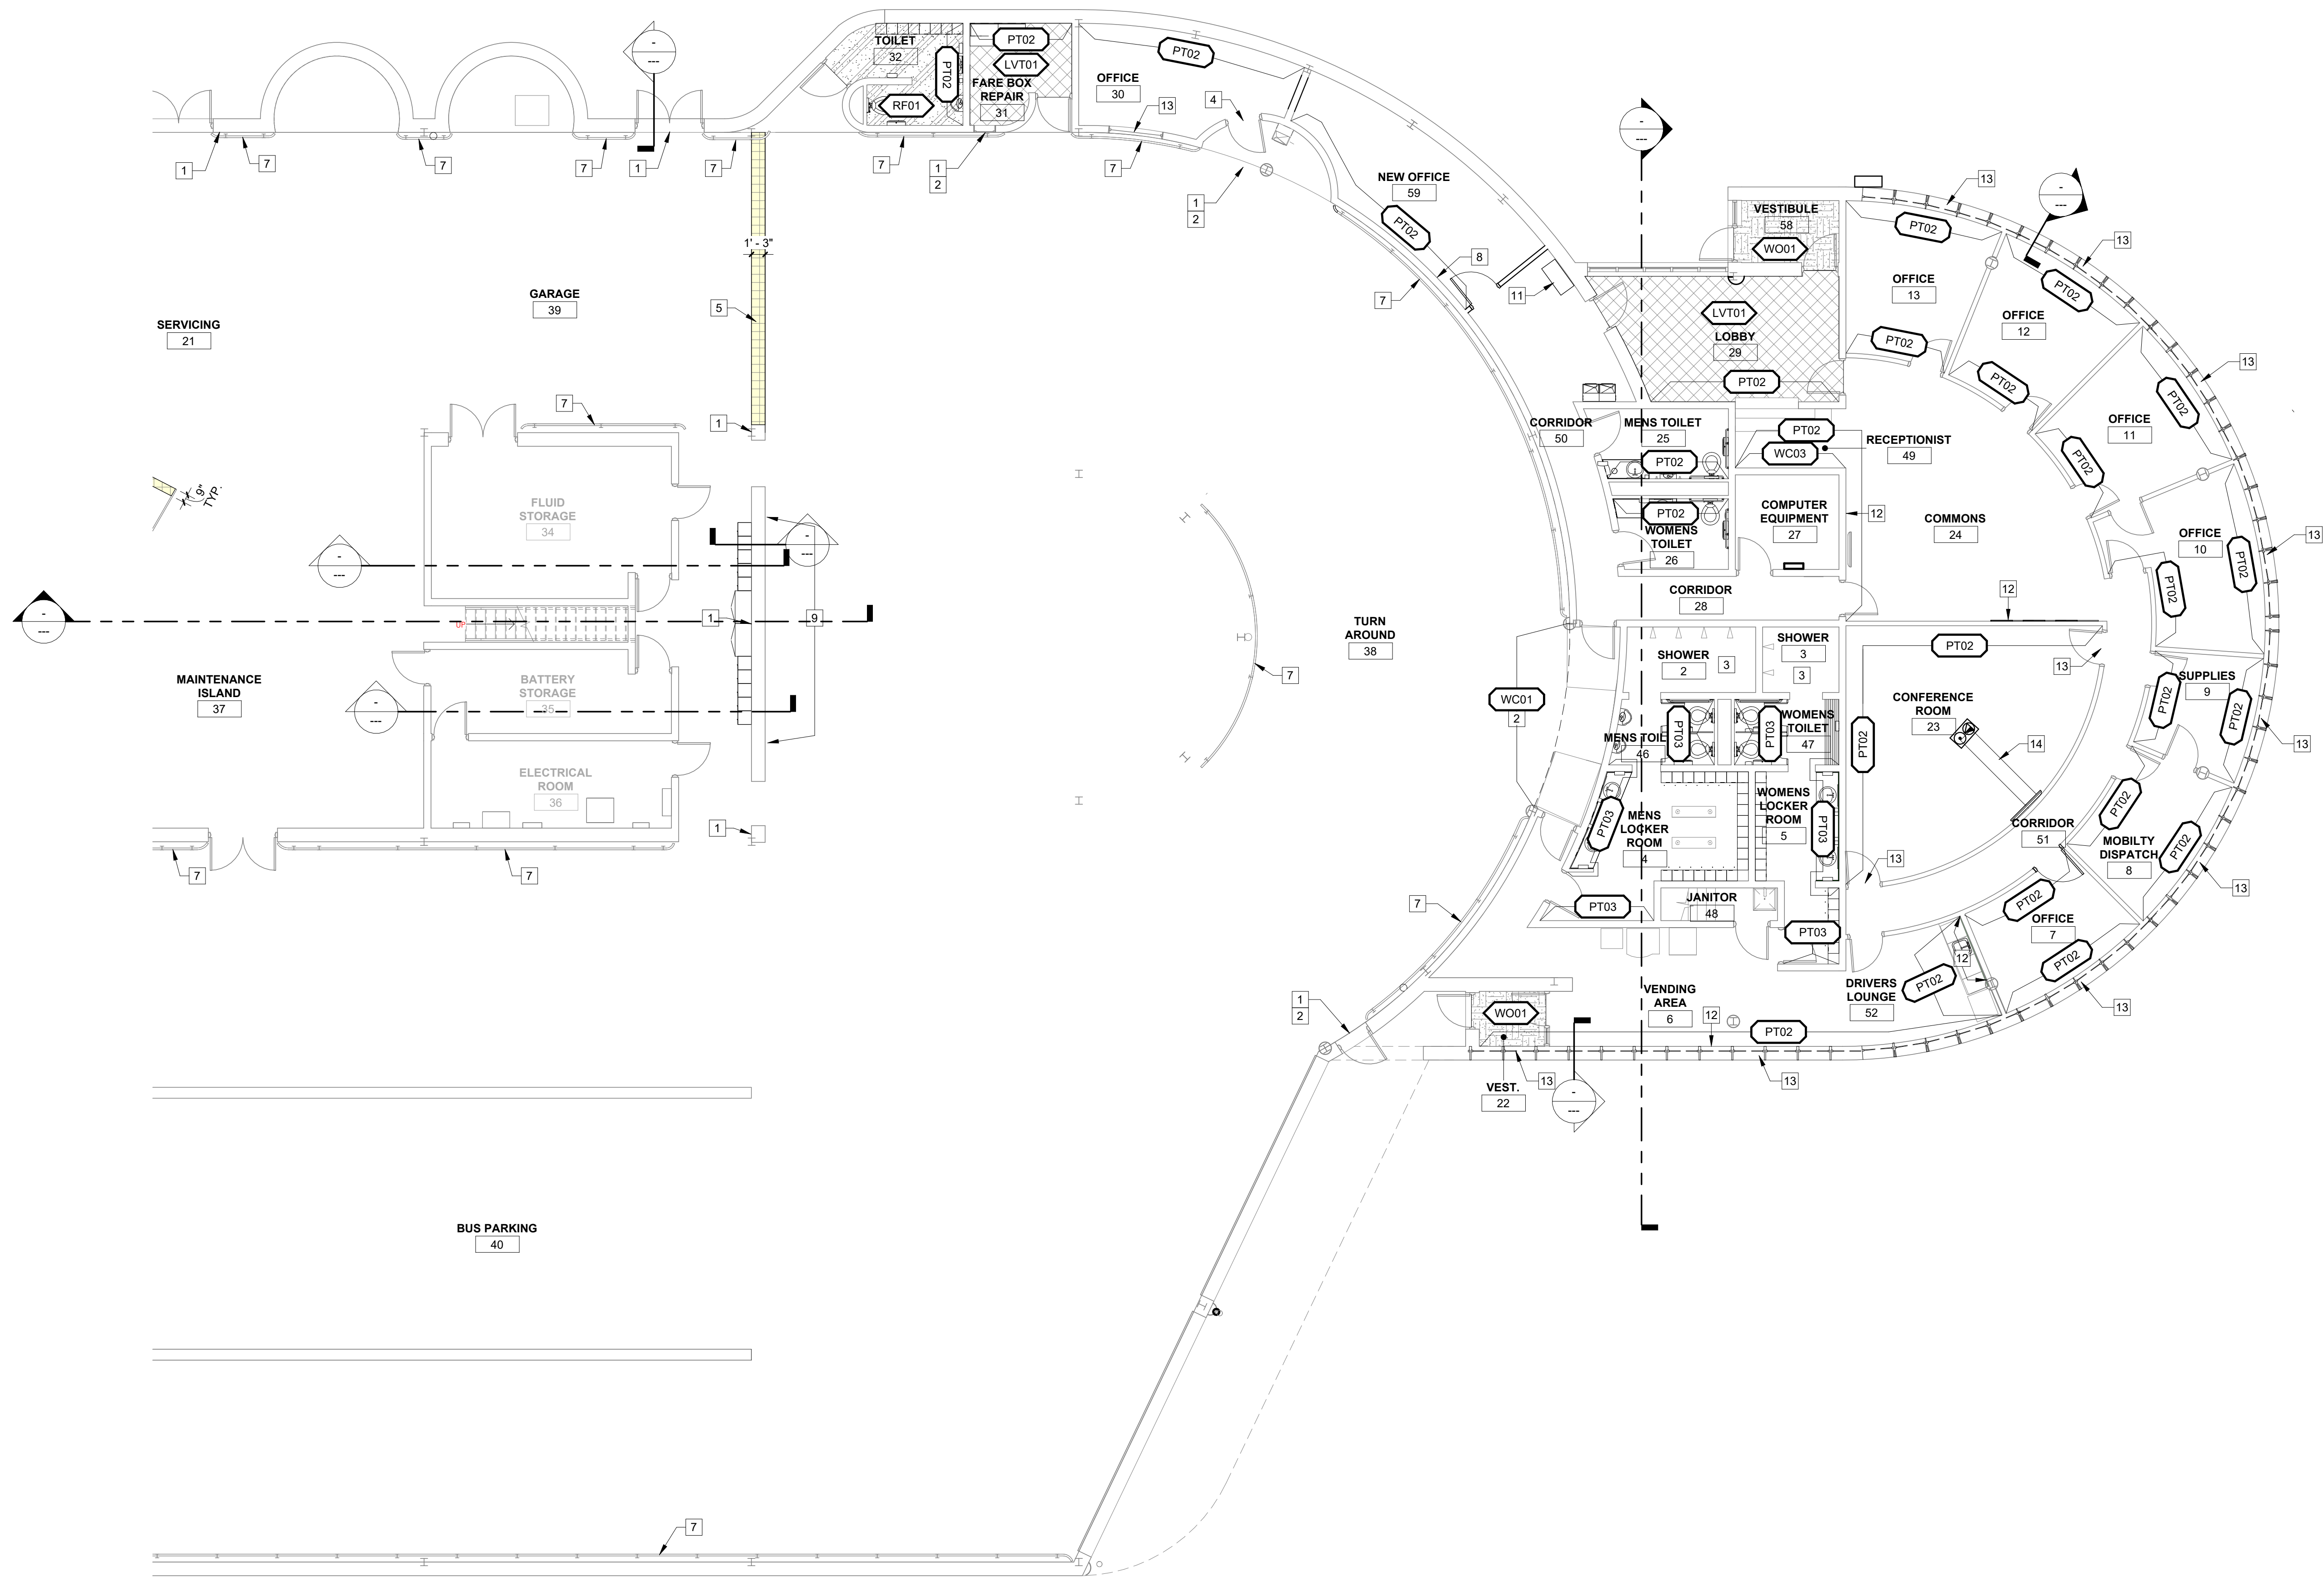

FINISH FLOOR PLAN - EAST

1/8" = 1'-0"

GENERAL INTERIOR FINISH NOTES

- A. ALL INTERIORS NOTES, SCHEDULES AND LEGENDS REFERENCE ABCD LEGEND. REFER TO VIEW HEADER OF ROOM FINISH SCHEDULE.
- B. PROVIDE RESILIENT OR METAL TRANSITION STRIP AT ALL FLOORING MATERIAL JUNCTURES. WHERE MATERIALS TRANSITION AT DOORS CENTER OF TRANSITION TO BE LOCATED ON CENTER OF DOOR. REFER TO DETAILS FOR TYPICAL FLOOR MATERIAL TRANSITIONS. COLOR SELECTED BY ARCHITECT FROM MANUFACTURES FULL RANGE OF COLORS.
- C. ALL EXPOSED GYP. CEILINGS AS WELL AS UNDERSIDE AND FACES OF BULKHEADS, AND SOFFITS TO BE PAINTED. REFER TO FINISH SCHEDULE FOR CEILING FINISHES AND REFLECTED CEILING PLANS FOR CEILING MATERIAL EXTENTS AND FINISH REQUIREMENTS. COORDINATE ANY PAINT FINISHES WITH ARCHITECT IN FIELD BEFORE PROCEEDING WITH FINISH WORK.
- D. REFER TO DOOR SCHEDULE FOR CLARIFICATION OF DOOR MATERIALS. ALL HOLLOW METAL DOORS AND HOLLOW METAL FRAMES TO BE PAINTED BOTH SIDES, PT02.
- E. ALL EXPOSED GYP WALLS TO BE PAINTED UNLESS NOTED OTHERWISE.
- F. ALL DIFFUSERS TO BE PAINTED TO MATCH ADJACENT WALL FINISH. VERIFY COLOR WITH ARCHITECT IN FIELD.
- G. PAINT FINISH SHEEN SCHEDULE: WALLS - EGGSHELL ACRYLIC LATEX; HOLLOW METAL DOORS AND FRAMES - SEMI GLOSS WATERBASED ALKYD URETHANE ENAMEL; CEILING - FLAT ACRYLIC LATEX; RESTROOM - EGGSHELL EPOXY; UNLESS NOTED OTHERWISE.
- H. WINDOW SILLS TO BE PLASTIC LAMINATE, PL02, SCOPE NOTED ON ARCHITECTURAL PLAN AND ELEVATIONS, NOTE 36.
- I. REFER TO FINISH FLOOR PLANS FOR PAINT ACCENT LOCATIONS AND FLOOR FINISH PATTERNS AND EXTENTS.
- J. REFER TO INTERIOR ELEVATIONS FOR CASEWORK FINISH LOCATION.
- K. WHERE NEW FINISHES WOULD MATCH EXISTING FINISHES, OR NEW FINISHES ARE NOT REQUIRED, MAINTAIN EXISTING FINISHES WHERE POSSIBLE DURING DEMOLITION AND CONSTRUCTION PHASE FOR REUSE. PATCH AND MATCH EXISTING FINISHES WHERE DISTURBED BY CONSTRUCTION.
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FINISH PLAN REFERENCE NOTES:

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3. ALTERNATE WORK: CLEAN EXISTING FLOOR TILE AND GROUT.
4. NEW WINDOW SHADE, RWS01.
5. ALTERNATE WORK: SAFETY YELLOW VINYL FLOOR STRIPING.
6. ALTERNATE WORK: PAINT RAILING SAFETY YELLOW, PT06, REFERENCE A1.2 & A1.3 FOR SCOPE OF WORK.
7. ALTERNATE WORK: PAINT END CAPS OF GUARD RAILS SAFETY YELLOW, PT08, REFERENCE A1.2 & A1.3 FOR SCOPE OF WORK.
8. PATCH FLOORING WITH LVT01, REPLACE +/- 12 TILES.
9. ALTERNATE WORK: PAINT ALL EXPOSED SIDES OF DUCTWORK PT01.
10. NEW WINDOW SHADE, RWS02.
11. LATERAL FILE STORAGE, OWNER FURNISHED, OWNER INSTALLED.
12. REFERENCE ELEVATION FOR FINISHES.
13. BASE BID: EXISTING HORIZONTAL BLINDS TO REMAIN ALTERNATE: NEW RWS01.
14. ALTERNATE WORK: PATCH FLOORING TO MATCH EXISTING WHERE AFFECTED BY DEMOLITION/NEW CONSTRUCTION.

Renovations to METS Garage and Transfer Terminal




Garage - 601 John St. Evansville, IN 47713

Transfer Terminal - Sixth St. & Sycamore St. Evansville, IN 47630

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In association with:



GARAGE KEY PLAN

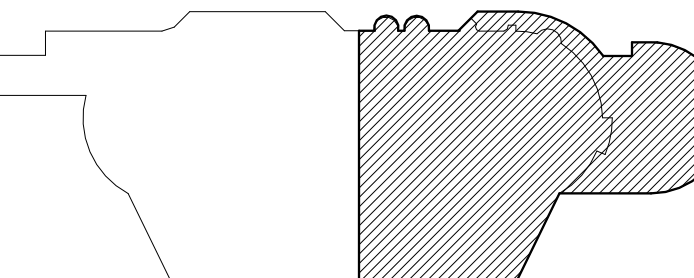NOT TO SCALE



Thomas W. Blythe

Revisions:

#	Description	Date
1	ADD-001	2025/09/12

Designed By: Drawn By: Checked By:

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Sheet title:

GARAGE FINISH PLAN EAST

Architect's Project No: Date:

2411-351 August, 2025

Drawing No:

ID1.2