

ADDENDUM

Project: 4th & Main Park Addendum No.: 001

400 Main Street

Evansville, IN 47708 Date: September 22, 2025

Owner: Evansville Parks and Recreation Project Number: 2404-183

100 E Walnut Street

Evansville, IN 47713 Contract for: General

The original specifications and drawings dated September, 2025 for the project noted above are amended as noted in this Addendum Number 001. Receipt of this addendum and any subsequent addenda must be acknowledged on the final bid documents. This addendum consists of 6 item(s) and attachment(s).

1. Reminder: Sealed bids are due by 12 PM CDT on October 1, 2025, at location outlined in specifications.

Drawings.

- 1. Drawing sheet LA101, SITE DEMOLITION PLAN: Delete Drawing Sheet LA101 in its entirety and replace with new drawing sheet LA101, SITE DEMOLITION PLAN, attached to this Addendum.
- 2. Drawing sheet LA509, SITE DETAILS: Delete Drawing Sheet LA509 in its entirety and replace with new drawing sheet LA509, SITE DETAILS, attached to this Addendum.
- 3. Drawing sheet U101, SITE UTILITIES PLAN: Delete Drawing Sheet U101 in its entirety and replace with new drawing sheet U101, SITE UTILITIES PLAN, attached to this Addendum.
- 4. Drawing sheet U201, SITE UTILITY DETAILS: Delete Drawing Sheet U201 in its entirety and replace with new drawing sheet U201, SITE UTILITY DETAILS, attached to this Addendum.
- 5. Drawing sheet U202, SITE UTILITY DETAILS: Delete Drawing Sheet U202 in its entirety and replace with new drawing sheet U202, SITE UTILITY DETAILS, attached to this Addendum.
- 6. Drawing sheet E1.2, LIGHTING FIXTURE SCHEDULE: Delete Drawing Sheet E1.2 in its entirety and replace with new drawing sheet E1.2, LIGHTING FIXTURE SCHEDULE, attached to this Addendum.

Attachments: Pre-Bid Meeting Agenda, Pre-Bid Meeting Sign-in Sheet, LA101, LA509, U101, U201, U202,

E1.2

By: Matthew Maloney

CC:

PRE-BID MEETING CITY OF EVANSVILLE Responsible Bidder Ordinance

Contacts:

Purchasing Department: Leigh Anne Williams 812-436-4917 www.lwilliams@evansville.in.gov

Dachenae Streeter 812-436-4915 dstreeter@evansville.in.gov

Building Commission: Cathy Evenson, cevenson@evansville.in.gov 812-436-7880

I. QUALIFICATIONS OF BIDDERS/LOCAL CONTRACT PROVISION

- Evansville Municipal Code (EMC) Chapter 3.95 provides requirements for contractors bidding on public construction projects which are outlined in:
 - o EMC 3.95.020 Random Drug Testing Program Requirements
 - o EMC 3.95.030 Contractor's License Requirement at Time of Bid Submission
 - It is the responsibility of the Prime Contractor to check with the Building Commission office to make sure they, along with their Subcontractors, have all necessary licenses to undertake the work called for in the bid.
 - EMC 3.95.040 Responsible Bidding Practices and Submission Requirements
- The Responsible Bidding Ordinance (RBO) applies to Public Works Projects over \$150,000.
 - This is different than IDOA requirements for State Public Works Projects found in IC 4-13.6-4
- RBO Certification term is a calendar year, and must be renewed annually.
- There is not a publicly available list of RBO certified companies. Certified companies will have a current "Prequalified" letter stating they are RBO certified.

Prime Contractors

- o RBO certification for the Prime Contractor is required at the time of bid submission.
- Must be properly licensed by the Evansville-Vanderburgh County Building Commission by the time of Bid Submission
- Prequalified Responsible Bidders, for the current year, shall provide the RBO prequalification letter with their bid.

Subcontractors

- General/Prime Contractors shall provide a written list disclosing the name, address and type of work for each first-tier subcontractor
- o RBO qualification requirements apply to subcontractors, regardless of Subcontractors cost.
- o RBO qualification of Subcontractors is required by contract execution
- Rule of Thumb: If employee is doing on-site, physical/manual labor then RBO certification is likely required.
- Following scopes of work are exempt from RBO certification:
 - Professional Services
 - Supplier
 - Trucking

• Bid Submission Requirements:

- o RBO certification for the **Prime Contractor** must be included with the bid package.
- o RBO certification for the **Subcontractors**:
 - If Subcontractor is already RBO certified by bid submission, include copy of "Prequalified" Letter with the bid.
 - If not, the certification is required to be submitted prior to the contract execution between awarded Contractor and Owner.
- o Licensing Requirements
 - Prime Contractors must have copies of all necessary licenses.
 - Subcontractors must have copies of required licenses, depending on scope of work.
 - If exempt, submit written verification from the Building Commission.
 - Exclusion from Contractor's license does not necessarily absolve RBO certification for Subcontractors.

RUNDELL ERNSTBERGER ASSOCIATES

Meeting Agenda

Meeting Date: September 15, 2025
Meeting Time: 1:00 PM, CDT

Meeting Location: CK Newsome Community Center, Evansville, Indiana

Project Number: 2025-1789

Project Name: 4th and Main Park, Evansville, Indiana

Items of Discussion:

A. INTRODUCTIONS

- 1. Owner's Representatives
 - a. Danielle Crook, Executive Director, Evansville Parks, dcrook@evansville.in.gov, 812.435.2536
 - b. Paul Bouseman, Deputy Director, Evansville Parks, <u>pabouseman@evansville.in.gov</u>, 812.435.6043
- 2. Consultant's Representatives
 - a. Matthew Maloney, Architect, Hafer, mmaloney@haferdesign.com, 618.457.5709
 - b. Pete Andriot, Rundell Ernstberger Associates (REA), pandriot@reasite.com, 502.561.8676

B. SIGN-IN SHEET

1. Please sign. Sign-in sheet and agenda will be included in next addendum.

C. PROJECT DESCRIPTION AND SCOPE OF WORK

1. Development of a one-half acre urban park at the intersection of 4th and Main Streets in Evansville. Including but not limited to: site demolition, earthwork, restroom building, performance building, storm sewer, sanitary sewer, water service, lighting, concrete pavements and seatwalls, suspended pavements, landscape and irrigation, site furnishings and other Work indicated in the Contract Documents.

D. DELIVERY METHOD

1. Single Prime Contract, lump sum.

E. ALTERNATES, ALLOWANCES AND UNIT PRICES

- 1. Alternates:
 - a. Alternate No. 1A: (may be accepted without 1B)
 - i. Provide unit paver pavement in park interior.
 - ii. Base Bid: Concrete pavement throughout park.
 - iii. Alternate: Unit Pavers within the park.
 - b. Alternate No. 1B: (will not be accepted without 1A)
 - i. Provide unit paver pavement in public right-of-way.
 - ii. Base Bid: Concrete pavement throughout right-of-way.
 - iii. Alternate: Unit Pavers in 4th Street and Main Street right-of-way.
 - c. Alternate No. 2A: (may be accepted without 2B)
 - i. Provide wood seating system for seatwalls.
 - ii. Base Bid: Cast-in-place concrete seatwalls.
 - iii. Alternate: Add wood seating system to concrete seatwalls.



- d. Alternate No. 2B: (will not be accepted without 2A)
 - i. Provide LED accent lighting for seatwalls.
 - ii. Base Bid: Cast-in-place concrete seatwalls, no lighting.
 - iii. Alternate: Add LED accent lighting to wood seating system.
- e. Alternate No. 3:
 - i. Provide soil cells for street trees in 4th Street right-of-way.
 - ii. Base Bid: Provide soil cells within park property only with minimal tree-pit excavation in right-of-way.
 - iii. Alternate: Excavate 4th Street right-of-way to depth necessary, install soil cells per plans, details, and specifications.
- f. Alternate No. 4:
 - i. Provide fixed shade umbrellas in park.
 - ii. Base Bid: No umbrellas.
 - iii. Alternate: Install umbrellas and foundations.
- 2. Unit Prices:
 - a. Reference the Bid Form Supplements.



F. PARALLEL WORK PERFORMED BY OTHERS

- 1. 5th and Main Development (the Vault): CRG and their subcontractors are building a five-story multi-use development on adjacent parcels north and east of the park property. Contractor shall coordinate with CRG for scheduling and sequencing of their work. Access to the development courtyard through the CenterPoint easement shall be maintained. Existing site fence is owned and maintained by CRG and shall be perpetuated for the project duration.
- 2. Electrical: CenterPoint will install underground primary services and equipment within their easements north and east of the park property. Contractor shall coordinate with CenterPoint for scheduling and sequencing of work.
- 3. Storm Sewer: City Engineering will bid a project to repave Main Street travel lane and install storm sewer pipe stub under the travel lane into sidewalk for this project to connect onto. Contractor shall coordinate with City Engineer for scheduling and sequencing of work.

G. INTERPRETATION OF BID DOCUMENTS/QUESTIONS DURING BID

- 1. All bidder questions shall be submitted in writing to Paul Bouseman at Evansville Parks. pabouseman@evansville.in.gov. Questions will be answered via Addenda only.
- 2. Last day for contractor questions is September 23, 2025. All questions must be submitted in writing on or before that date. Questions received after that date will not be answered.

H. BID ADDENDUM

- 1. Acknowledge receipt on Bid Form Supplements.
- 2. Additional Addenda, if necessary, will be issued on or before September 24.

I. BID OPENING

- 1. Owner will receive sealed lump sum bids until the bid time and date as follows:
 - a. Bid Date: Wednesday, October 1, 2025.
 - i. Prior to 11:45 AM, deliver sealed bids to Purchasing Department, Room 223.
 - ii. After 11:45 AM, but no later than Noon, deliver sealed bids to City Council Chambers, Room 301.
 - b. Bid Time: 12:00 PM (Noon) local time (CDT)
 - c. Location: Submit bids in a sealed envelope, clearly addressed on the outside as follows: IFB-508-06-2025

4TH AND MAIN PARK

1 NW Martin Luther King Jr. Blvd, Room 323

Evansville, IN 47708

 Bids will be publicly opened and read aloud on October 1, 2025, at 12:00 PM (noon), local time (CDT) at Civic Center Administration Building, Council Chambers, Room 301, 1 NW Martin Luther King Jr. Blvd, Evansville, IN 47708.

J. COMPLETION TIME & PROJECT SCHEDULE

- 1. Bid Opening: October 1, 2025
- 2. Motion to Award Contract: October 15, 2025
- 3. Notice to Proceed: November 5, 2025 (or earlier).
- 4. Substantial Completion: July 1, 2026

K. OBTAINING PLANS AND SPECIFICATIONS

1. Online Procurement and Contracting Documents: Obtain access online at: https://www.evansvillegov.org/city/department/division.php?structureid=133



L. REQUIRED BID SUBMITTALS

- 1. Bid Sheet
- 2. Bid Sheet Supplements
- 3. Receipt of Addenda
- 4. Letters of reference (3)
- 5. Indiana Bid Form 96 (completed)
- 6. EEO Statement
- 7. E-Verify Statement
- 8. Warranty Information for Equipment to be installed
- 9. Bid Bond
- 10. Flash Drive

M. MAINTENANCE OF TRAFFIC

- 1. Maintain pedestrian access at corner of 4th and Main at all times. Sidewalks can be closed on either/both streets adjacent to the project, but the pedestrian corner must remain open.
- 2. Maintain access to CenterPoint easements at all times (paving operations notwithstanding).
- 3. Do not block vehicular through-traffic on Main Street or 4th Street without prior approval from the Safety Board or Board of Public Works. Temporary lane restrictions are possible, but only with written prior approval. ROW Permit may be required, depending on duration.

N. PERMITS

- 1. APC Site Review
- 2. Restroom and Performance Building: Indiana DHS (and Comcheck)

O. QUESTIONS

RUNDELL ERNSTBERGER ASSOCIATES

Meeting Sign-in

Meeting Date:

September 15, 2025

Meeting Time:

1:00 PM

Meeting Location:

CK Newsome Community Center

Project Number:

2025-1789

Project Name:


4th and Main Park, Evansville, Indiana

Subject:

Pre-bid Meeting



Name	Organization	Email Address
Pete Andriot	REA	pandriot@reasite.com
HUNTER FIELDS	S.A.M.M. EXCAVATING	hfieldse samm trucking.com
JARED DRENNAN	MIDWEST	JORENNAN @MWCONTRACTING. CO
MARK LOVELACE	KLENCH	MARN@IDPCLIC. COM
Austin Jones	KLENCK	austin Q Klenck Company, com
Chris Krampe	Arc Construction	Chrampe@arc-construction.com
Eric Bradshaw	River Town Construction	
MART BLYTHE	LOIZERSTEINS	mbly the ckobersteins. com
NATHAN WILDEMAN	OEIG Bros.	NATHONE DELL BROS. COM
Danny Martin	Danco Construction	Kait@danco-const. com
Mya Johnson	empire contractors	Bits@ emrire-Contactors.com
Clay Will	HFI	cwill@harrell-fish.com
Colby Frazier	Garmong	Ctraziera garmong.net
Coser Seller	Sellers Masory	sellersinco icloud, com
,		1

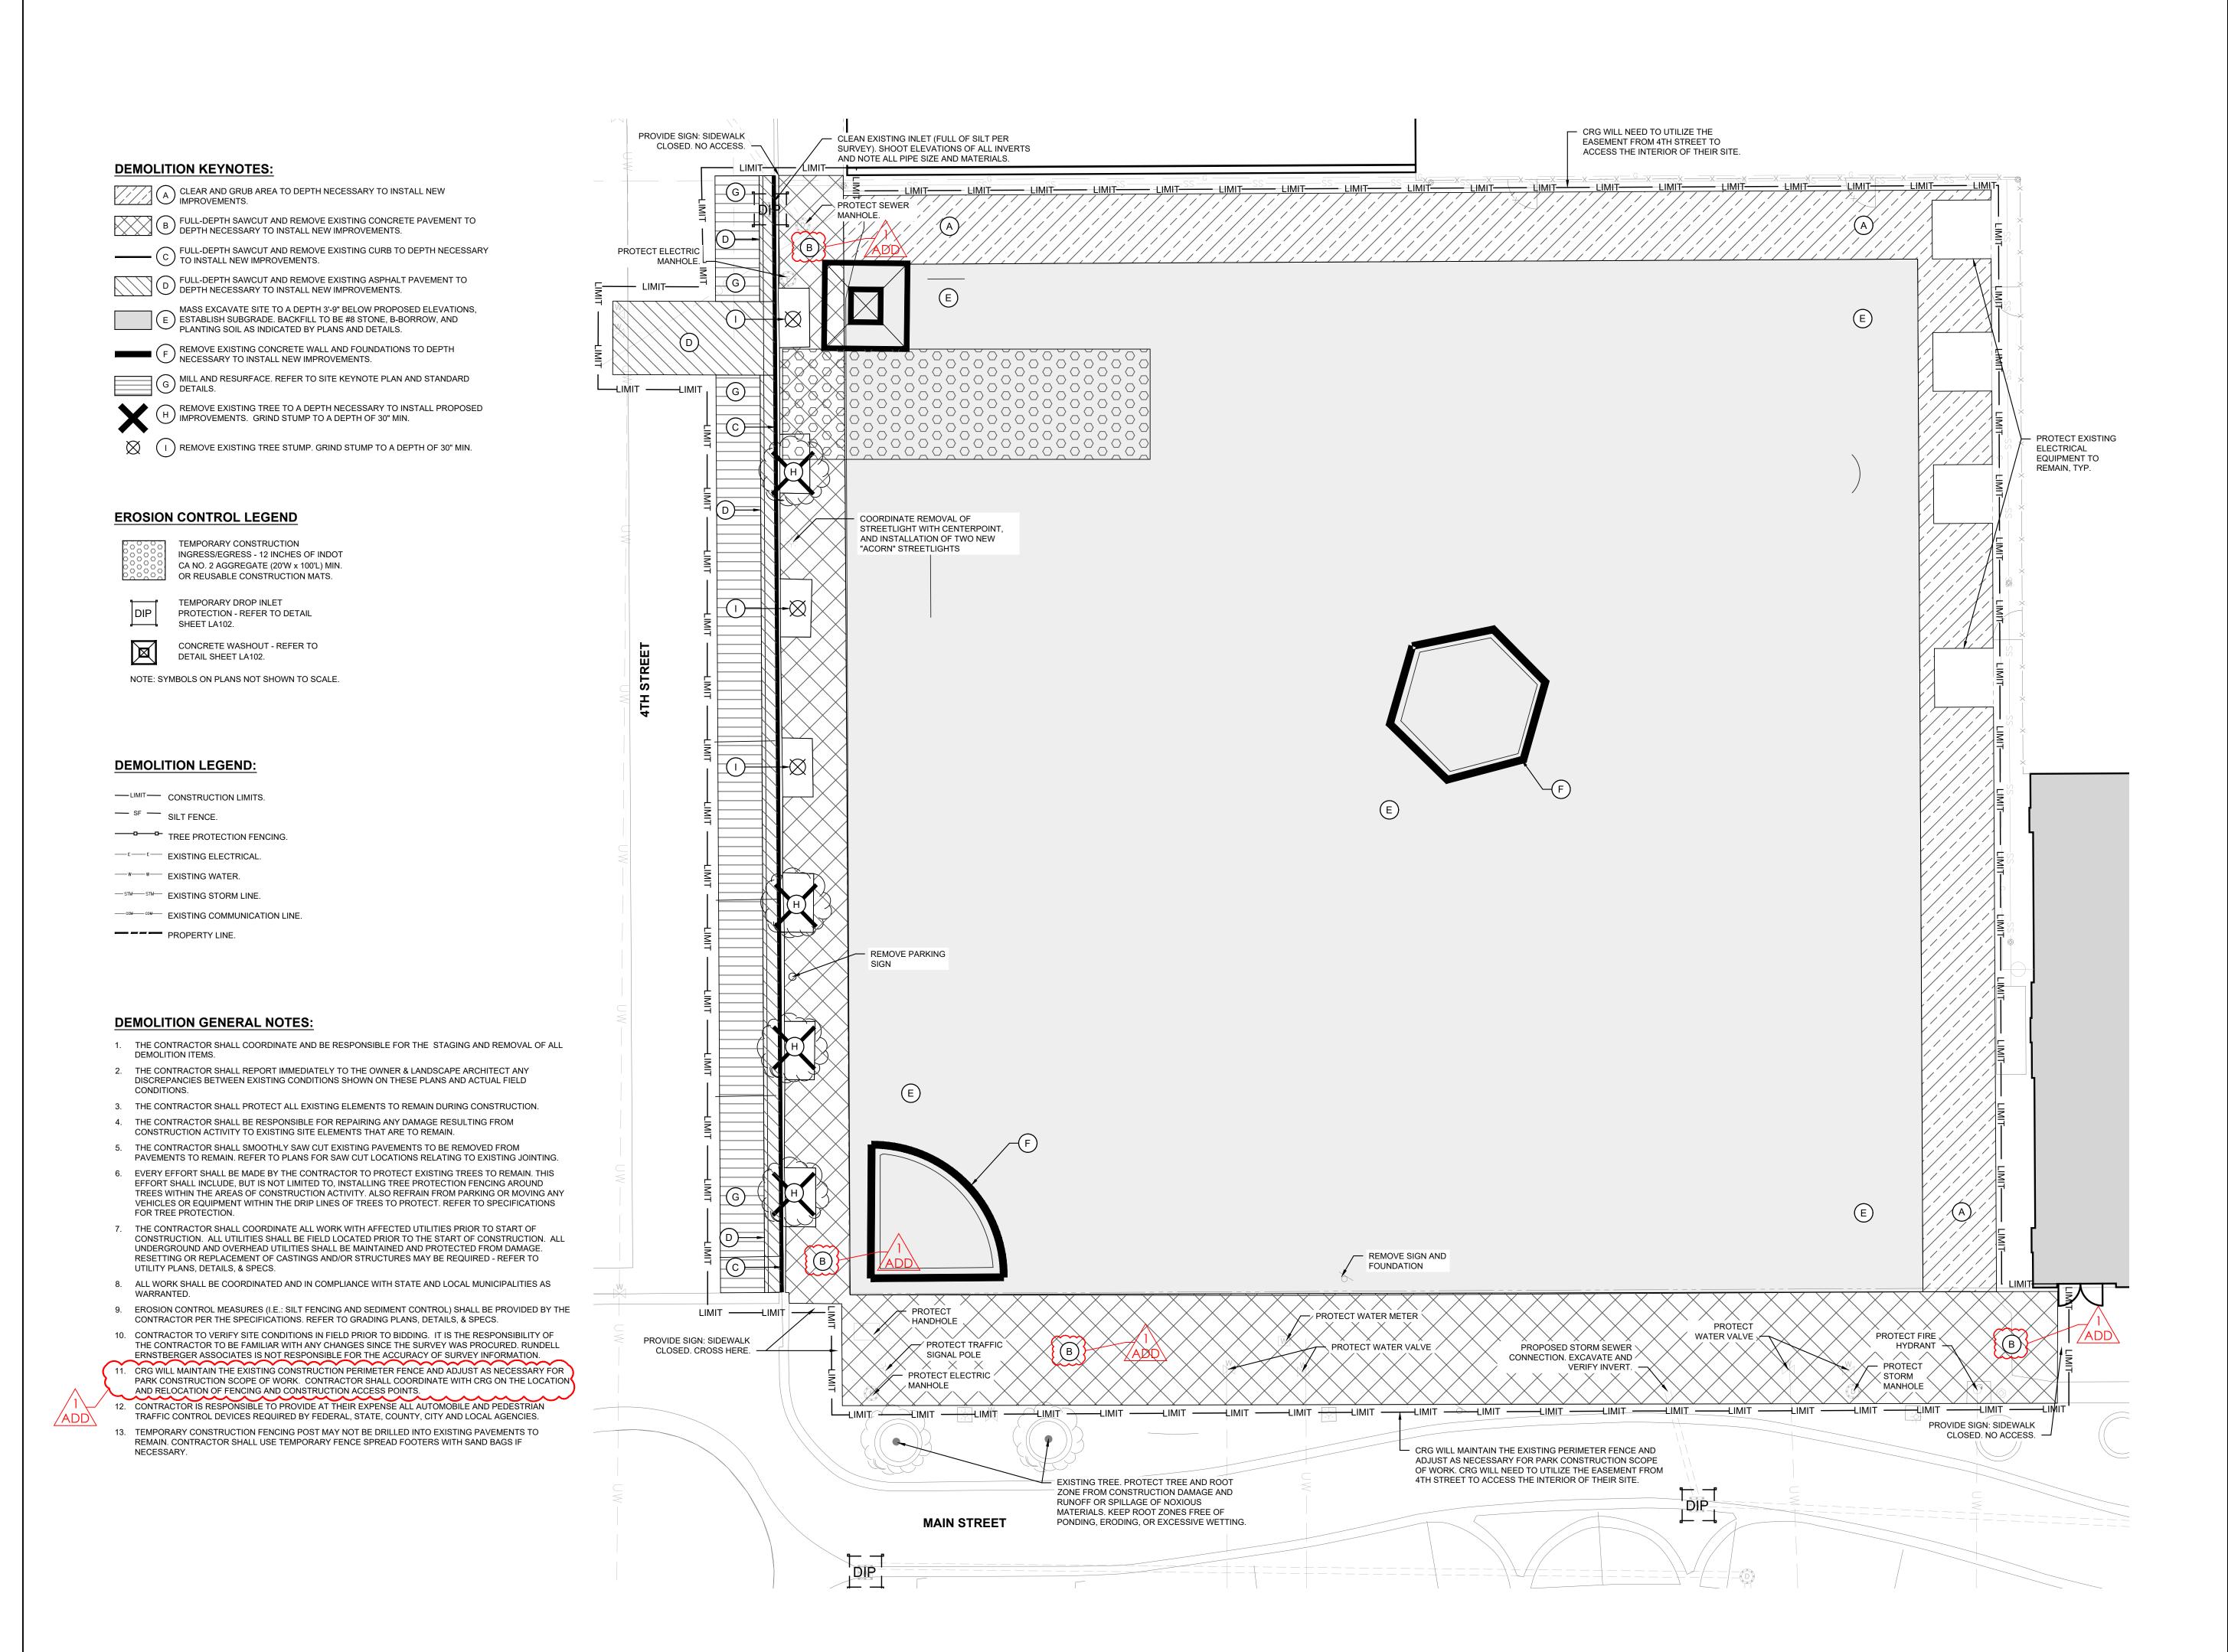

4TH AND MAIN PARK



IFB-508-06-2025 DOWNTOWN EVANSVILLE, INDIANA

Suite 800 Evansville, IN 47708 architects • designers • engineers F: 812.421.6776 www.haferdesign.com

In association with:



STRUCTURAL ENGINEERING



8440 Allison Pointe Blvd Suite 425 Indianapolis, IN. 46250



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Sheet title:


SITE DEMOLITION PLAN


Architect's Project No:

September 2025


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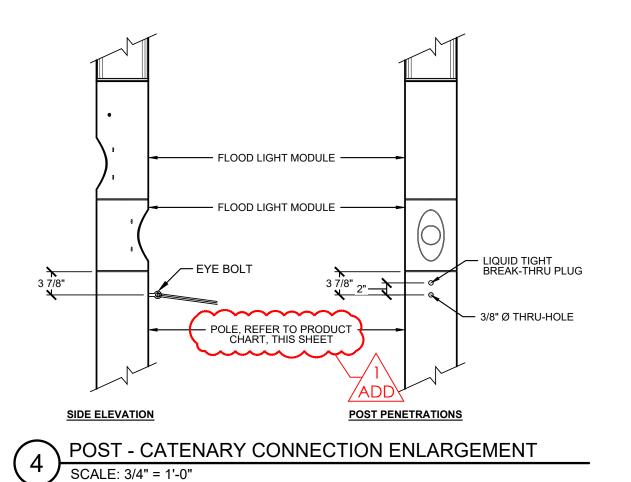
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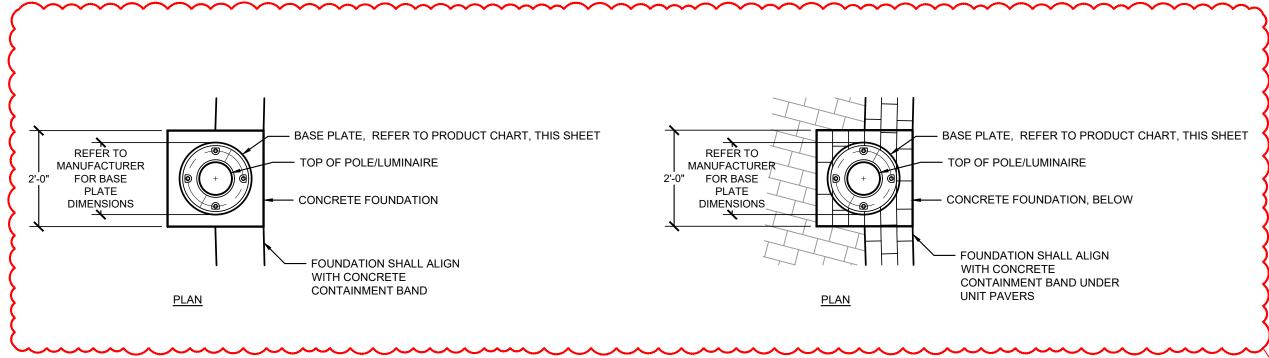


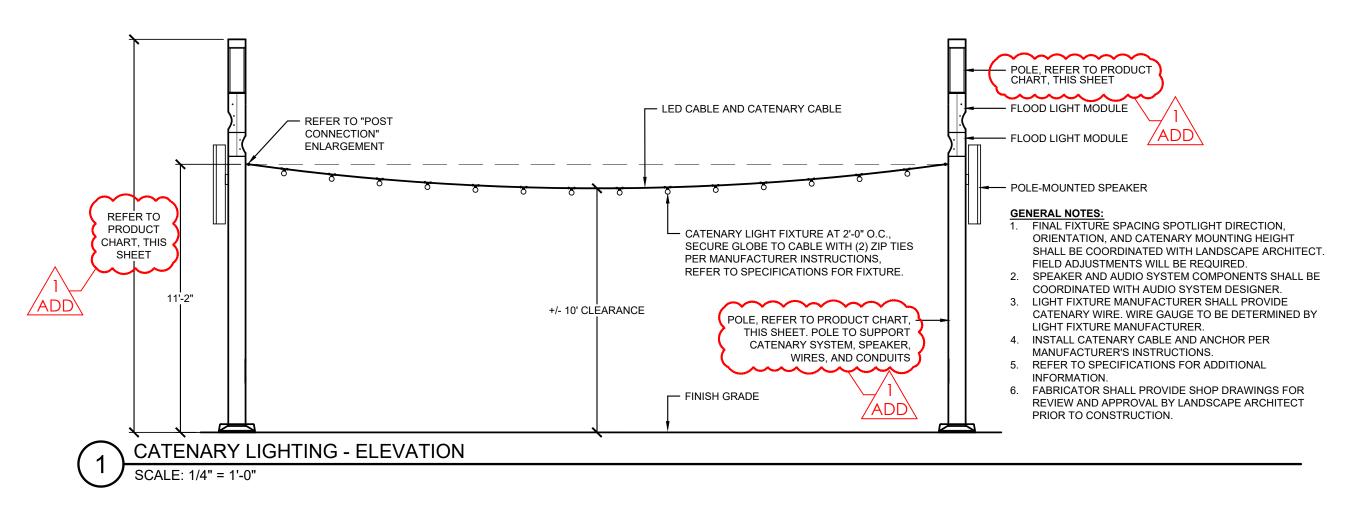



LUMINAIRE/ MEDIA POLE - MOUNTING DETAIL SCALE: 1/2" = 1'-0"

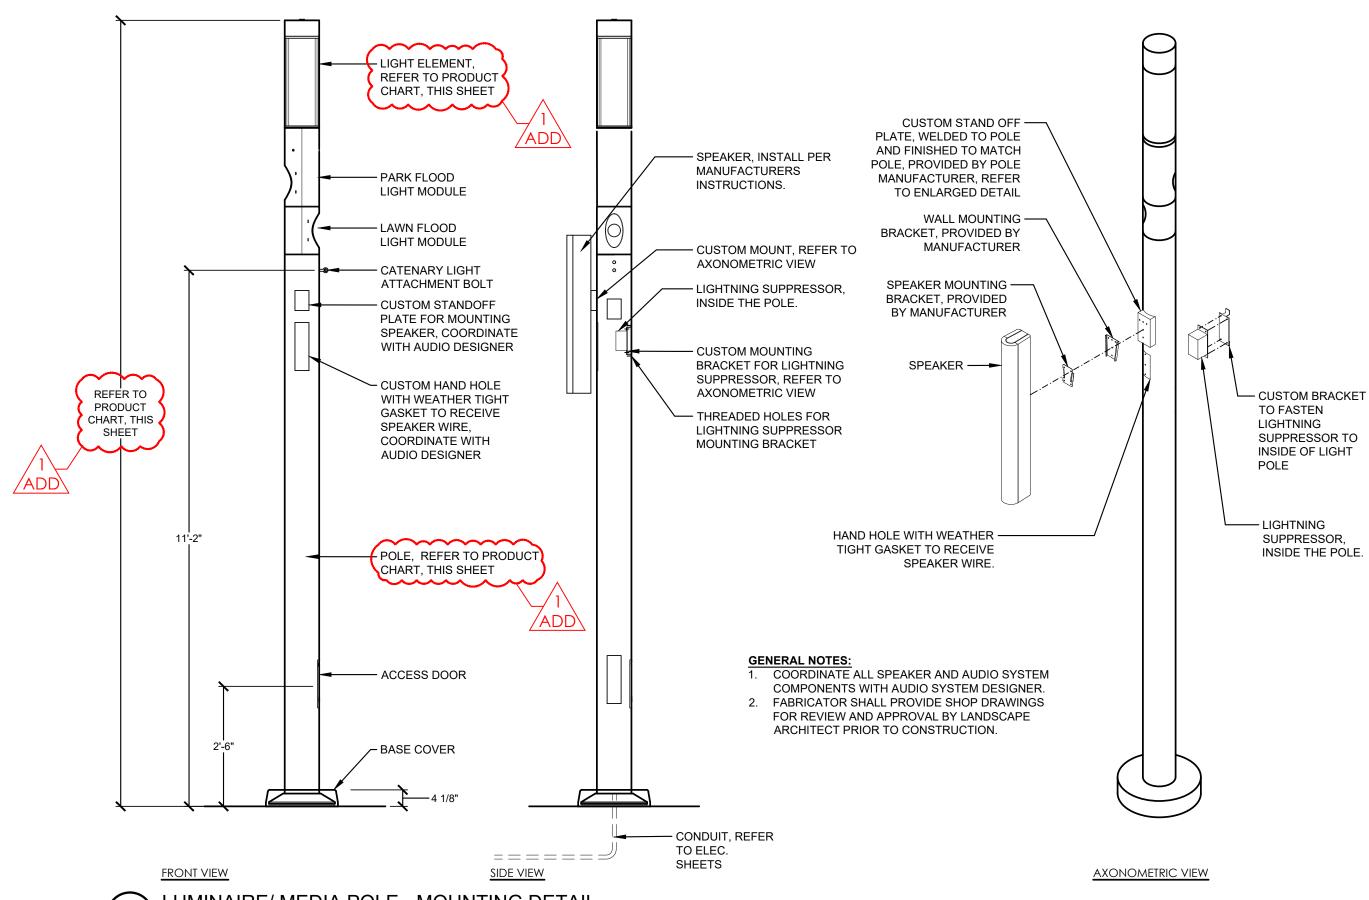



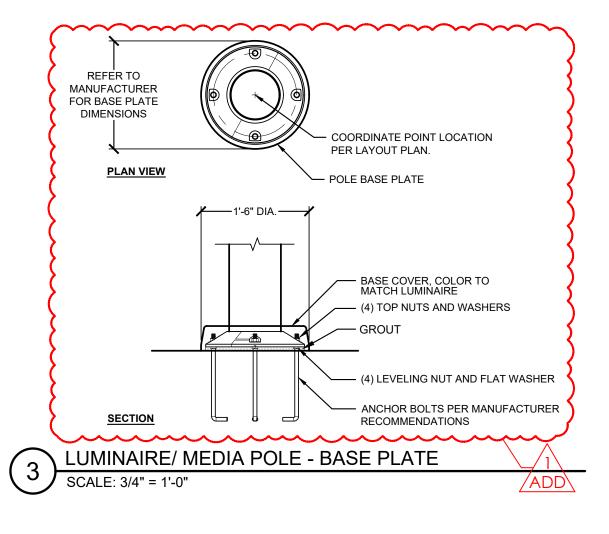


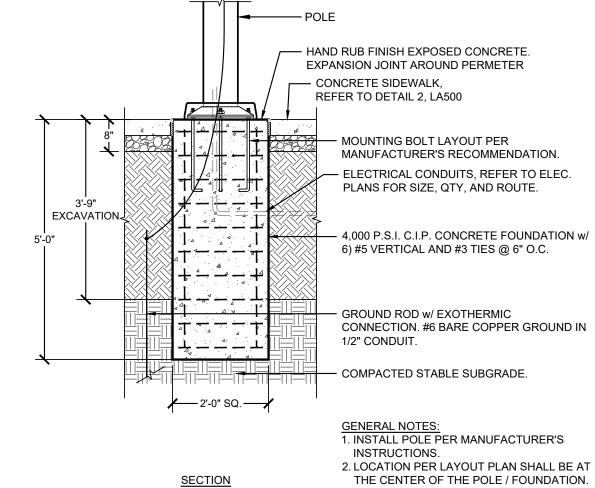

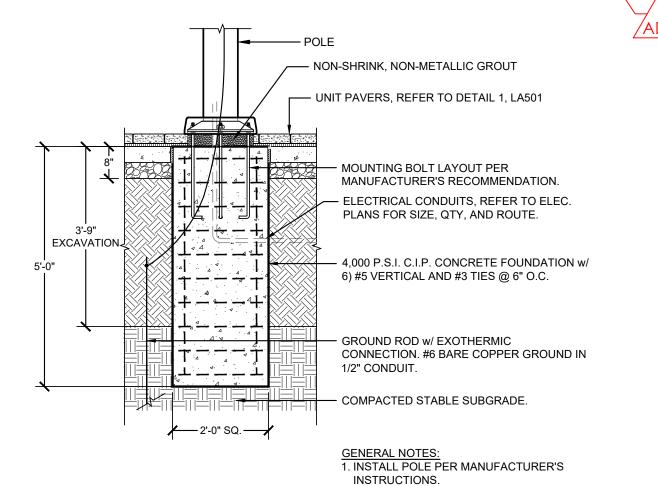

LUMINAIRE / MEDIA POLE FOUNDATION (BASE BID) SCALE: 1/2" = 1'-0"

LUMINAIRE / MEDIA POLE PRODUCT CHART

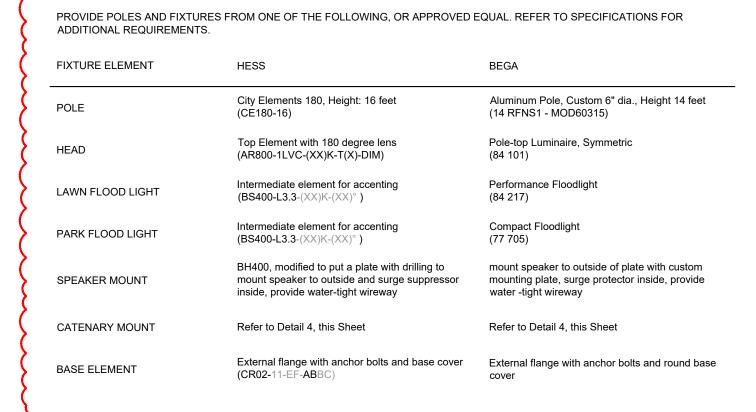

4TH AND MAIN PARK

IFB-508-06-2025

DOWNTOWN

EVANSVILLE, INDIANA

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URBAN PLANNING/LANDSCAPE ARCHITECTURE/CIVIL ENGINEERING

In association with:

618 E. Market St. Indianapolis, IN. 46202

STRUCTURAL ENGINEERING

Suite 800

Evansville, IN 47708

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applicable approved modifications. Sheet title:

SITE DETAILS

Architect's Project No:

September 2025

Drawing No:

Date:


2. LOCATION PER LAYOUT PLAN SHALL BE AT 8440 Allison Pointe Blvd Suite 425 Indianapolis, IN. 46250 <u>SECTION</u> THE CENTER OF THE POLE / FOUNDATION. LUMINAIRE / MEDIAPOLE FOUNDATION (ALTERNATE) SCALE: 1/2" = 1'-0"

GENERAL UTILITY NOTES:

- 1. THE UTILITIES SHOWN HEREIN HAVE BEEN LOCATED FROM FIELD SURVEY INFORMATION AND RECORD DRAWINGS. THE ENGINEER MAKES NO GUARANTEE THAT THE UTILITIES SHOWN COMPRISE ALL SUCH UTILITIES IN THE AREA, EITHER IN SERVICE OR ABANDONED. FURTHERMORE, THE ENGINEER DOES NOT WARRANT THAT THE UTILITIES SHOWN ARE IN THE EXACT LOCATION INDICATED, ALTHOUGH HE DOES CERTIFY THAT THEY ARE LOCATED AS ACCURATELY AS POSSIBLE FROM THE INFORMATION AVAILABLE.
- 2. THE CONTRACTOR SHALL BE RESPONSIBLE FOR OBTAINING, OR VERIFYING, THAT ALL PERMITS AND APPROVALS ARE OBTAINED FROM THE RESPECTIVE CITY, COUNTY, AND STATE AGENCIES PRIOR TO STARING CONSTRUCTION.
- 3. IT SHALL BE THE CONTRACTOR'S RESPONSIBILITY TO DETERMINE THE EXACT LOCATION OF ALL EXISTING UTILITIES IN THE VICINITY OF THE CONSTRUCTION AREA PRIOR TO STARTING CONSTRUCTION.
- 4. IT SHALL BE THE CONTRACTOR'S RESPONSIBILITY TO NOTIFY AND COORDINATE WITH LOCAL AND PRIVATE UTILITIES FOR NECESSARY UTILITY RELOCATIONS.
- 5. IT SHALL BE THE CONTRACTOR'S RESPONSIBILITY TO MAINTAIN QUALITY CONTROL THROUGHOUT THE PROJECT. FAILURE TO DO SO MAY RESULT IN REMOVAL AND REPLACEMENT OF THE DEFECTIVE WORK.
- 6. IT IS ESSENTIAL THAT THE WORK TO BE DONE IN CONJUNCTION WITH THIS PROJECT SHALL BE INSTALLED ACCORDING TO THESE SPECIFICATIONS. IT IS NECESSARY TO OBTAIN APPROVAL AND ACCEPTANCE BY THE CITY THAT CONSTRUCTION WAS DONE IN COMPLIANCE WITH THESE PLANS AND
- 7. ALL QUANTITIES GIVEN ON THE PRINTS, VERBALLY, OR IN THE SCOPE OF WORK SECTION ARE ESTIMATES AND SHALL BE CONFIRMED BY THE BIDDING CONTRACTOR.
- 8. OCCUPATIONAL SAFETY AND HEALTH ADMINISTRATION (OSHA) STANDARDS FOR EXCAVATION, FINAL RULE 29 CFR, PART 1926, SUBPART "P" APPLIES TO ALL EXCAVATIONS EXCEEDING FIVE (5) FEET IN
- 9. ACTUAL FIELD LOCATIONS OF ALL THE EXISTING UTILITIES ARE THE RESPONSIBILITY OF THE CONTRACTOR AND MUST BE LOCATED EITHER BY THE REPRESENTATIVE OF THE LOCAL UTILITY COMPANY OR BY A PRIVATE UNDERGROUND UTILITY LOCATION COMPANY PRIOR TO THE START OF EXCAVATING. VERIFY MINIMUM COVER REQUIREMENTS BY THE UTILITY CONTRACTOR OR CONTRACTORS, OR AGENCIES, WHICHEVER UTILITY COMPANY OR AGENCIES, THAT HAS JURISDICTION, SO NOT TO CAUSE DAMAGE.
- 10. IT IS THE RESPONSIBILITY OF THE CONTRACTOR TO NOTIFY ALL THE UTILITY COMPANIES AND DEPARTMENTS 72 HOURS BEFORE CONSTRUCTION IS TO START TO VERIFY ANY UTILITIES THAT MAY BE PRESENT ON THE SITE. ALL VERIFICATIONS, LOCATIONS, SIZES, AND DEPTHS SHALL BE MADE BY THE APPROPRIATE UTILITY COMPANIES OR DEPARTMENTS. WHEN EXCAVATING AROUND OR OVER EXISTING UTILITIES, THE CONTRACTOR MUST NOTIFY THE UTILITY COMPANY SO A REPRESENTATIVE OF THE UTILITY COMPANY CAN BE PRESENT DURING THE EXCAVATION TO INSTRUCT AND OBSERVE DURING THE
- 11. PIPE LENGTHS SHOWN ARE MEASURED FROM CENTER-TO-CENTER OF STRUCTURES ROUNDED TO THE NEAREST FOOT.
- 12. WHERE GRADE MODIFICATIONS (CUT OR FILL) ARE SHOWN ADJACENT TO EXISTING VALVE BOX COVERS AND MANHOLE CASTINGS, THE VALVE BOX COVERS AND MANHOLE CASTINGS SHALL BE ADJUSTED FLUSH WITH THE PROPOSED GRADE.
- 13. PAVEMENTS, WALKS, CURBS, AND OTHER SURFACE IMPROVEMENTS REQUIRING REMOVAL FOR INSTALLATION OF UNDERGROUND UTILITIES SHALL BE RESTORED TO THEIR PRESENT CONDITIONS
- 14. THE CONTRACTOR SHALL MAINTAIN ALL FLOWS AND UTILITY CONNECTIONS TO EXISTING BUILDINGS, STRUCTURES, AND FACILITIES WITHOUT INTERRUPTION UNLESS/UNTIL AUTHORIZED TO DISCONNECT BY THE OWNER, UTILITY COMPANY, AND/OR GOVERNING AUTHORITY. THE CONTRACTOR SHALL INSTALL AS NECESSARY TEMPORARY SITE LIGHTING, GAS, SANITARY, WATER, STORM, ELECTRIC, TELEPHONE, AND CABLE SERVICES TO SERVICE BUILDINGS INDICATED TO REMAIN OPEN.
- 15. THE CONTRACTOR SHALL PROVIDE ALL BENDS, FITTINGS, ADAPTERS, ETCETERA AS REQUIRED FOR PIPE CONNECTIONS TO FACILITY STUB OUTS.
- CAP STUBS AND PROVIDE FIELD MARKERS.
- 17. SANITARY BACKWATER VALVE SHALL BE RECTORSEAL 97026 CLEAN CHECK 6" PVE EXTENDABLE BACKWATER VALVE OR APPROVED EQUAL.
- 18. ALL PROPOSED STORM SEWER AND DRAINAGE APPURTENANCES SHALL BE IN CONFORMANCE WITH EVANSVILLE WATER AND SEWER UTILITY (EWSU) STANDARD DETAILS AND CHAPTER 13.04 OF THE VANDERBURGH COUNTY DRAINAGE ORDINANCE. DISCREPANCIES BETWEEN THE PLANS AND EWSU STANDARD DETAILS OR THE VANDERBURGH COUNTY ORDINANCE SHALL NOT ALLEVIATE THE CONTRACTOR FROM ADHERING TO THE REQUIREMENTS AS SET FORTH IN THE STANDARD DETAILS AND

CIVIL PLAN SYMBOLS AND ABBREVIATIONS:

ВС	BOTTOM OF CURB	MEG	MATCH EXISTING GRADE
TC	TOP OF CURB	RIM	RIM ELEVATION
EX	EXISTING	FFE	FINISH FLOOR ELEVATION
PR	PROPOSED		
——— H2O ———	WATER LINE	st	STORM SEWER
SAN —	SANITARY SEWER	——— UGE ———	UNDERGROUND ELECTRIC
— — — UD —	UNDERDRAIN	——— OHW———	OVERHEAD WIRE
—— ит ——	UNDERGROUND COMMUNICATION LINE	——— GAS ———	GAS LINE
•—(724.50)	EXISTING SPOT ELEVATION (VERIFY)	781	EXISTING CONTOUR LINE
78 (1.80	PROPOSED SPOT ELEVATION	● 781 —	PROPOSED CONTOUR LINE
1.0%	PROPOSED SLOPE	— GВ —	GRADE BREAK
WM T	WATER METER	X 	ABANDON STORM LINE
X _{V,V}	WATER VALVE	ST	STORM STRUCTURE
O co	CLEANOUT		AREA DRAIN, INLET
(SA)	SANITARY MANHOLE		

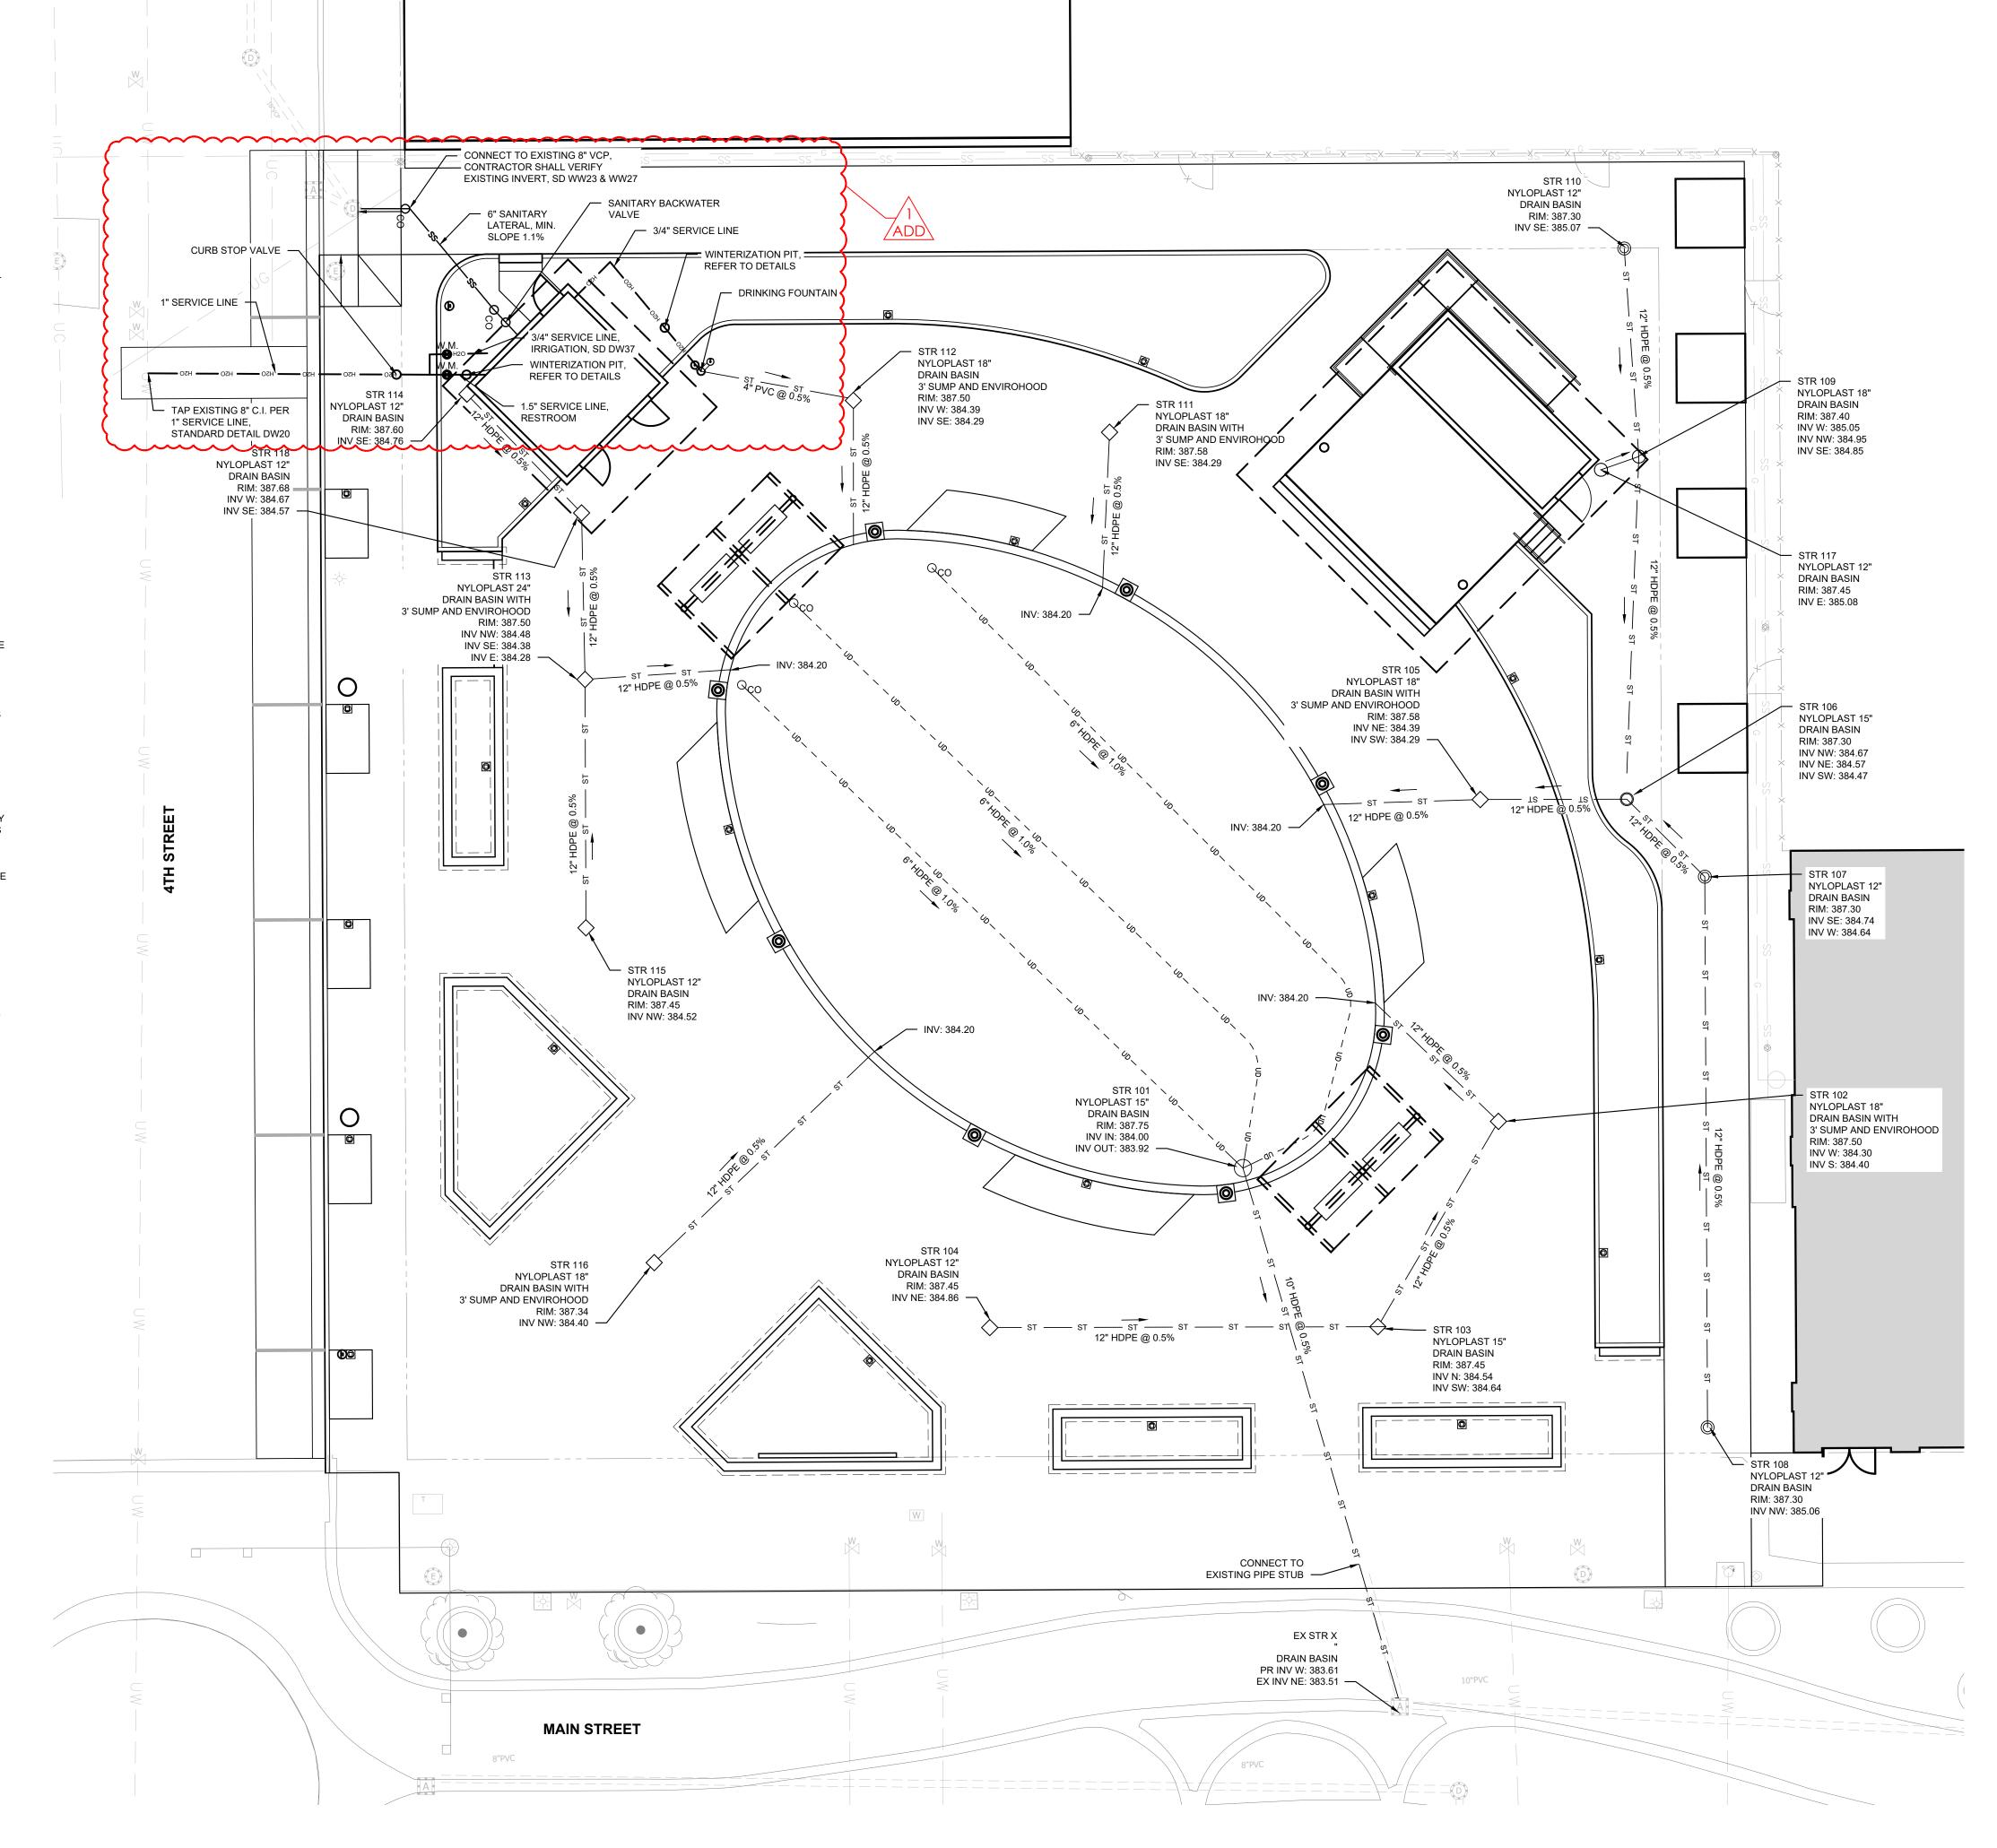






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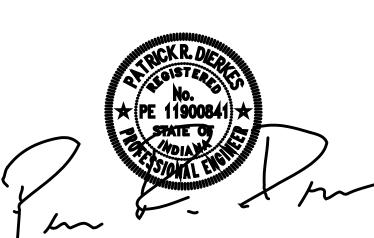
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618 E. Market St. Indianapolis, IN. 46202



8440 Allison Pointe Blvd Suite 425 Indianapolis, IN. 46250



Revisions:										
#										
01	ADDENDUM # 01	09/19/2025								
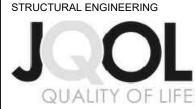
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Checked By:

Date:

applicable approved modifications. Sheet title:


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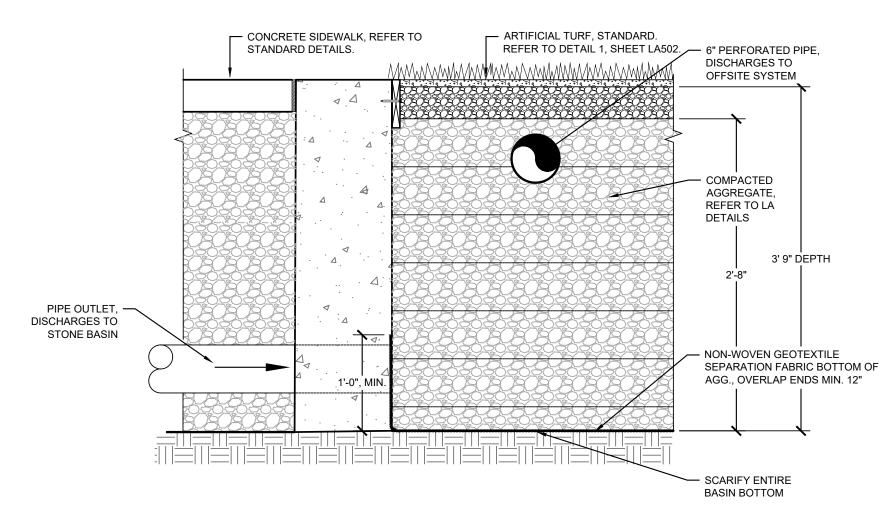
SITE UTILITIES PLAN

Architect's Project No:


September 2025

Drawing No:



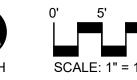



ARTIFICIAL TURF DETENTION AND DRAINAGE DETAIL

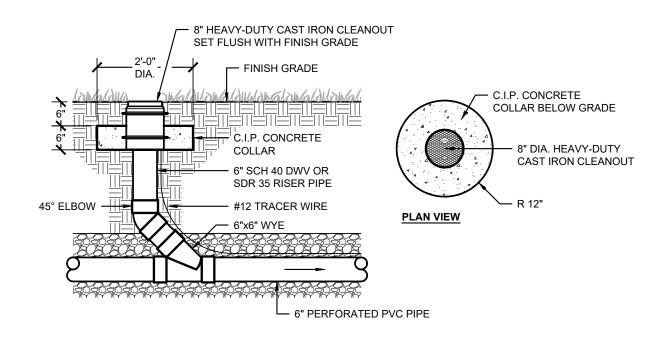

CLEANOUT IS REQUIRED AT EACH BEND THAT IS GREATER THAN 45-DEGREES.

SINGLE CLEANOUT, PERFORATED PIPE

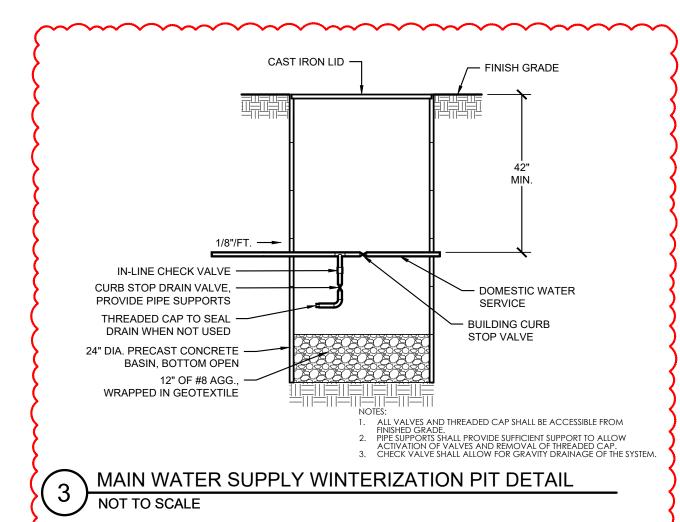

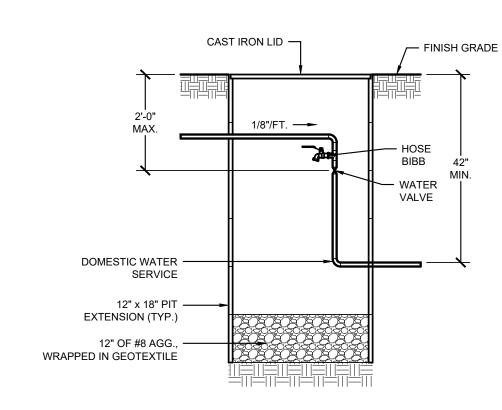

DRINKING FOUNTAIN WINTERIZATION PIT DETAIL

NOT TO SCALE

EWSU WATER SERVICES - GENERAL NOTES:

- Contractor shall comply with all local, state and federal codes, ordinances, rules, regulations, orders and other legal requirements of municipal authorities which bear on the performance of the work, which may not be recognized on the
- approved plan set.

 2. The contractor is cautioned that the location and / or elevation of existing utilities, as shown on these plans, is based on records of various utility companies, and where possible measurements taken in the field. The information is not to be relied on as being exact or complete. The contractor must contact the appropriate utility company at least 48 hours before any excavation to request exact field location of utilities. Contractor shall locate existing utilities and establish elevations and clearances with proposed improvements prior to initiating construction. Indiana underground utility locate service (ILIPSS) phone: 811

- Material specifications shall be in conformance with applicable portions of the IDEM standard specifications, (latest edition) unless specifically stated otherwise on these plans, contract documents, or EWSU Water and Sewer Manual.
 All water service taps shall be witnessed by an EWSU inspector. The contractor is to provide a minimum of 48-hour notice to Inspector (812-708-0502) before construction commences.
- Minimum of 18 inch vertical and 10 feet horizontal clearance to be maintained between water lines and sewer lines.
 Minimum separation between any water services shall be four feet, as measured from outside of pipe to outside of pipe.
 Any required easement shall be recorded and provided prior to start of construction.
 Taps shall be installed at the approved plan locations. Any desired location changes shall be approved by the EWSU utility inspector. Taps are not to be made within four feet of any other tap or fitting. No taps shall be made within two
- No services to be installed within eight feet of any side property line. All service lines from main to property line valve or meter shall run perpendicular to the main. Deflections of service line shall only occur after the EWSU property line valve or meter.
- 10. For Gate Valve operating nuts that are going to be deeper than five feet, Contractor shall provide stainless steel extensions.
 11. Any water use for interior fire protection or irrigation purposes shall be identified to EWSU prior to implementation for verification of proper Backflow Prevention.
- (PROJECT SPECIFIC) Owner/Developer/Applicant/Contractor shall secure a Street Cut permit through the City of Evansville Engineer's office (812-436-4973) for the work to be performed in the public road or alley right-of-way.
 CALL BEFORE YOU DIG – BURIED LINE LOCATION – CALL 811.

EWSU WATER SERVICES - PROJECT SPECIFIC NOTES:

(Notification to Start Job) Notify Inspector (812-708-0506) with the Evansville Water and Sewer Utility 48 Hours prior to start of any service construction. Coordinate with EWSU Inspector for all EWSU system interactions. All taps shall be witnessed by the Utility.
 Disclose all of the uses for the proposed 1" domestic service. Backflow protection is required for all Cross Connections.

Cross Connection is any physical arrangement whereby a public water supply is connected, directly or indirectly, with

any secondary water supply system, sewer, drain, conduit, pool, storage reservoir, plumbing fixture, or other device which contains or may contain any water, contaminated liquid, or other waste of unknown or unsafe quality that could impart a contaminant or pollutant to the drinking water as a result of backflow caused by backpressure or back siphonage.
 Owner/Developer/Applicant/Contractor shall secure a Construction Permit or Street Cut Permit through the City of

Evansville Engineer's office (812-436-4973) for the work to be performed in the public road or alley right-of-way.

CALL BEFORE YOU DIG - BURIED LINE LOCATION - CALL 811.

EWSU SANITARY SEWER TAP/CONNECTION - GENERAL NOTES

- The Licensed Contractor Plumber (Contractor) shall comply with all local, state and federal codes, ordinances, rules, regulations, orders and other legal requirements of municipal authorities which bear on the performance of the work, which may not be recognized on the approved plan set.
- The Contractor is cautioned that the location and/or elevation of existing utilities, as shown on these plans, is based on records of various utility companies, and where possible measurements taken in the field. The information is not to be relied on as being exact or complete. The Contractor must contact the appropriate utility company at least 48 hours before any excavation to request exact field location of utilities. Contractor shall locate existing utilities and establish elevations and clearances with proposed improvements prior to initiating construction. Indiana underground utility locate service (IUPSS) phone: 811.
- Material specifications shall be in conformance with applicable portions of the IDEM standard specifications, (latest edition) unless specifically stated otherwise on these plans, contract documents, or EWSU water and sewer manual.
 All sanitary sewer tap/connections shall be witnessed by an EWSU Inspector. The Contractor is to provide a minimum of 48 hour notice to Len Will (812-305-7514) before construction commences.
- Minimum of 18 inch vertical and 10 feet horizontal clearance to be maintained between water lines and sewer lines.
 Minimum depth of cover for sanitary sewer laterals is 3 feet to top of pipe.
 Any required easement shall be recorded and provided prior to start of construction.
 Taps shall be installed at the approved plan locations. Any desired location changes shall be approved by the EWSU
- Utility Inspector. Taps not to be made within 6 feet of any other tap. No taps or laterals to be made within 3 feet of any property line. No taps or laterals to be made within 6 feet of any utility pole or component.

 9. Bypass pumping and/or other methods may be necessary to complete the tapping of the existing sanitary sewers. The Contractor is responsible for adhering to the Evansville Sewer Overflow Response Plan (SORP) as it has to do with sewer overflow responsibilities.
- 10. (PROJECT SPECIFIC) Owner/Developer/Applicant/Contractor shall secure a Construction or Road Cut Permit through the City of Evansville engineer's office (812-436-4973) for the work to be performed in the public road or alley right-of-way.

EWSU SANITARY SEWER TAP/CONNECTION - PROJECT SPECIFIC NOTES:


- (Notification to Start Job) Notify Len Will (812-305-7514) with the Evansville Water and Sewer Utility 48 Hours prior to start of any sewer tap or connection construction. All taps/connections shall be witnessed by the Utility.
 Contractor to excavate for the existing 8" VCP main. The Contractor shall be prepared with video inspection capabilities for the EWSU Inspector to assess the viability of reuse of the main. If reusable, then install an EWSU cleanout (Detail WW-23) just behind the public sidewalk. If NOT reusable, then remove the lateral connection per Inspectors' instructions and install new lateral connections/tap.
 Provide building finish floor elevations. If lowest plumbing rim elevations are not one foot above the upstream MH rim,
- provide sanitary backflow preventer on the private plumbing.


 4. Contractor may install horizontal bends, fittings, or transition sizes and materials only upstream from the EWSU
- cleanout, per plumbing code.


 5. Owner/Developer/Applicant/Contractor shall secure permits from the City of Evansville Engineer's office (812-436-4973) for the work to be performed in the public road or alley right-of-way.
- Owner/Developer/Applicant/Contractor shall secure permits from the City of Evansville Engineer's office (812-436-497) for the work to be performed in the public road or alley right-of-way.

 CALL BEFORE YOU DIG BURIED LINE LOCATION CALL 811.



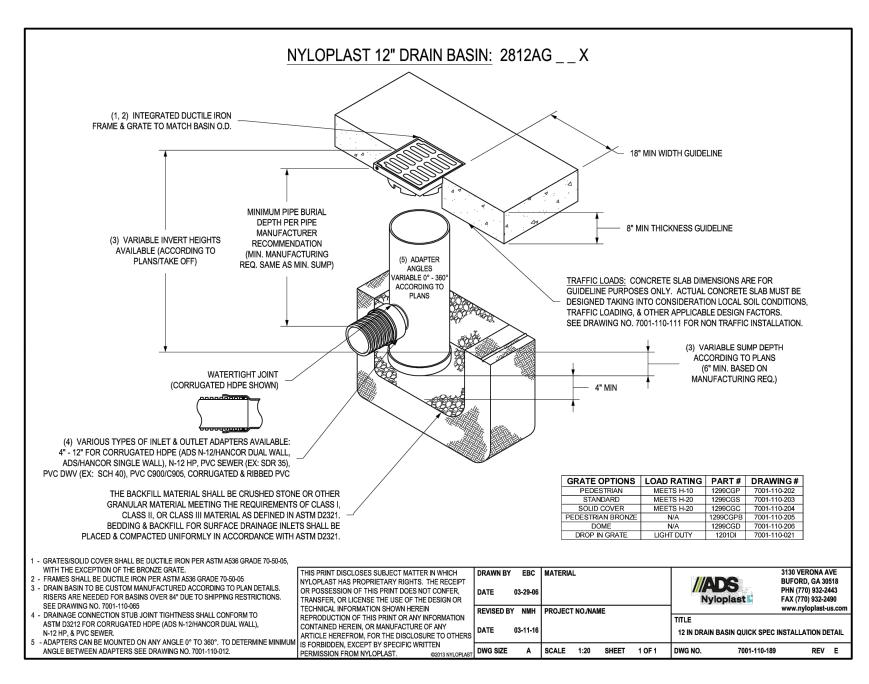

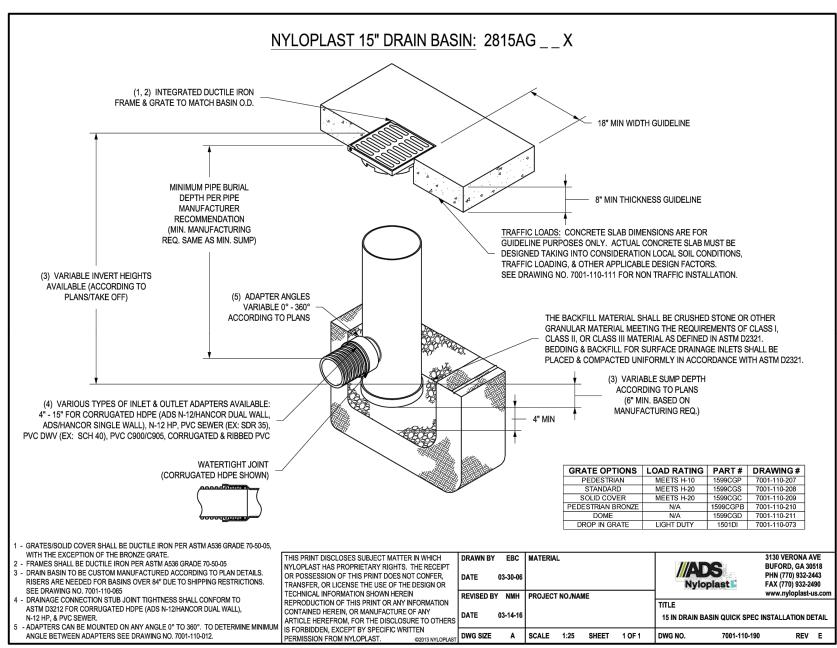

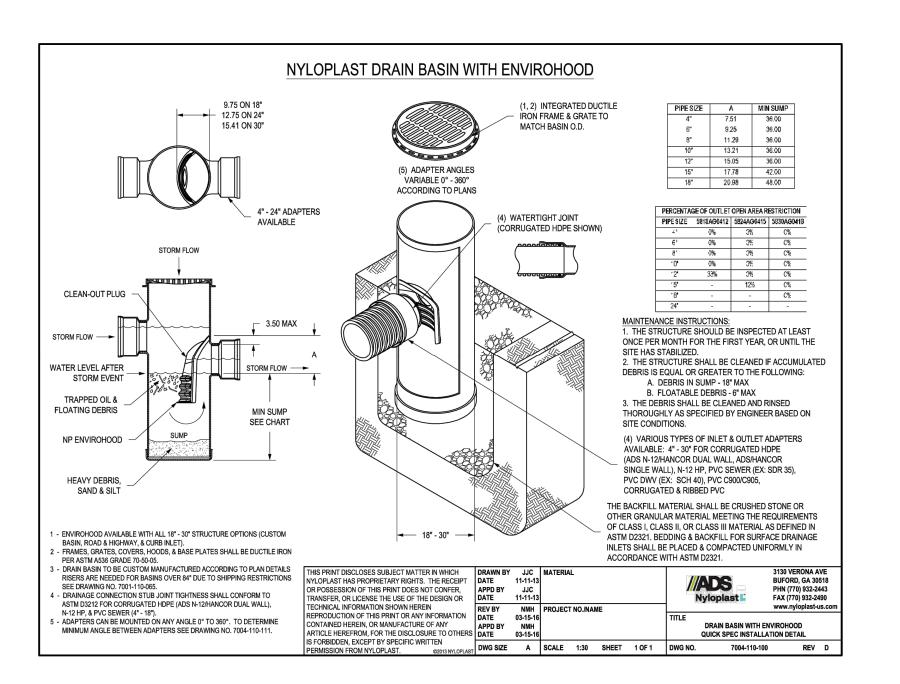





IFB-508-06-2025 DOWNTOWN EVANSVILLE, INDIANA



In association with:



STRUCTURAL ENGINEERING

QUALITY OF LIFE^{1M}
8440 Allison Pointe Blvd Suite 425 Indianapolis, IN. 46250



Revisions:

Description Date
01 ADDENDUM # 01 09/19/2025

Designed By:

LW/PA

LW/TJ

PA

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Sheet title:

SITE UTILITY DETAILS


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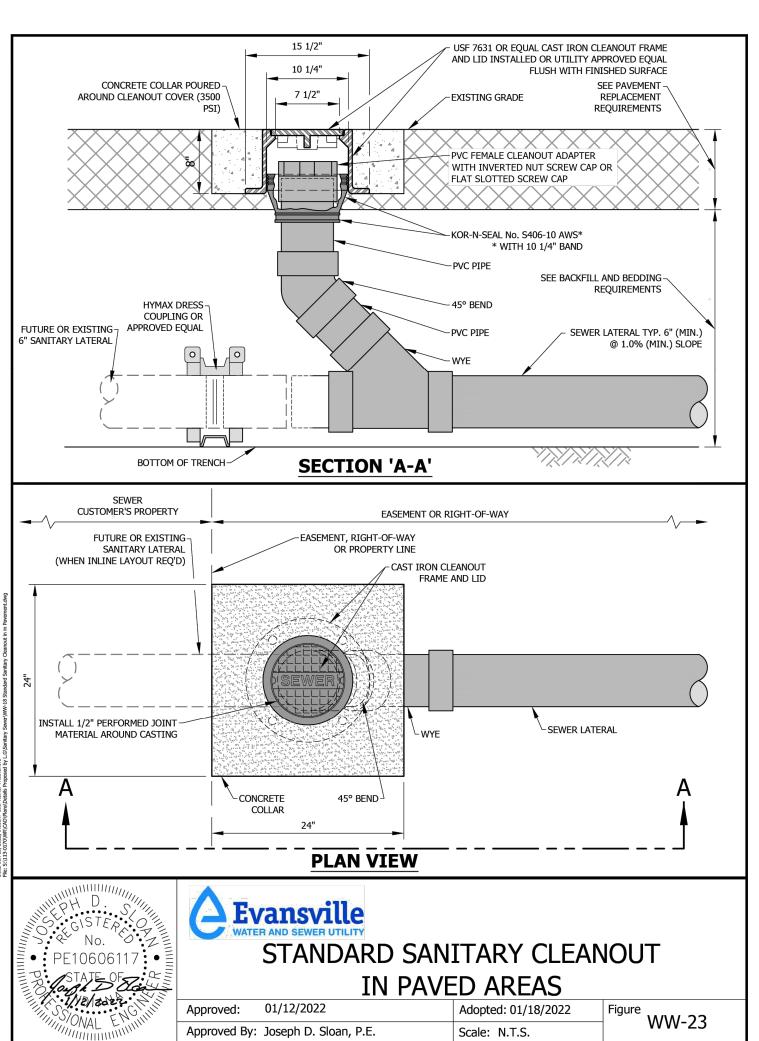
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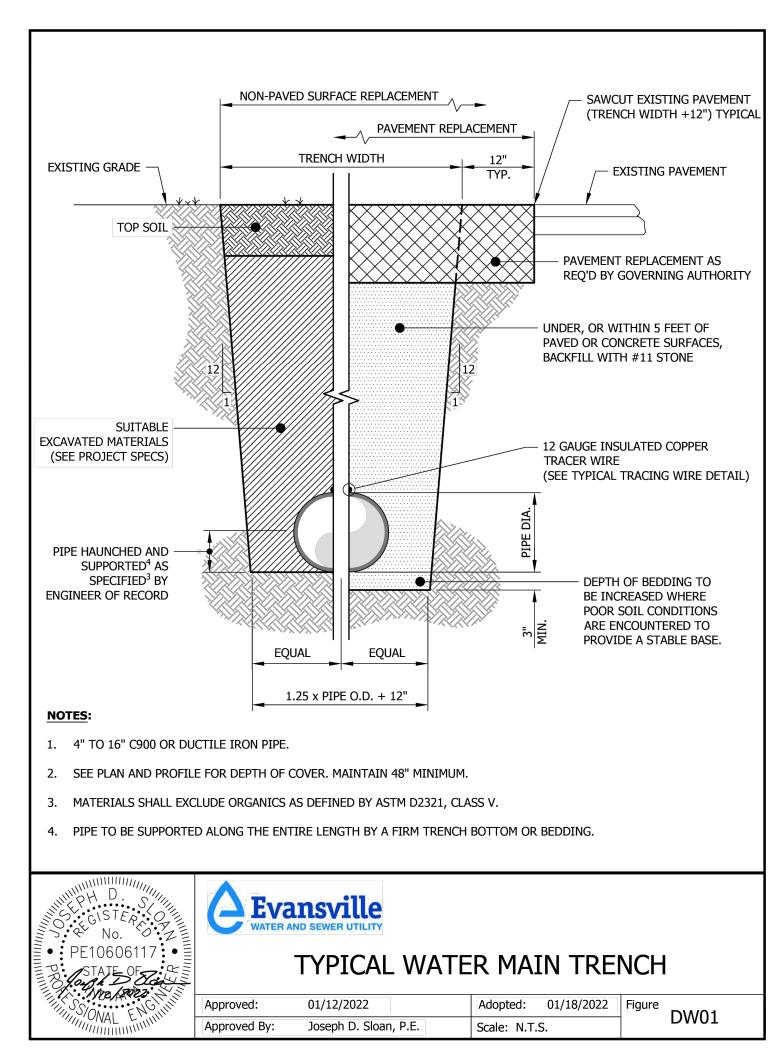
2024-183 September 2025


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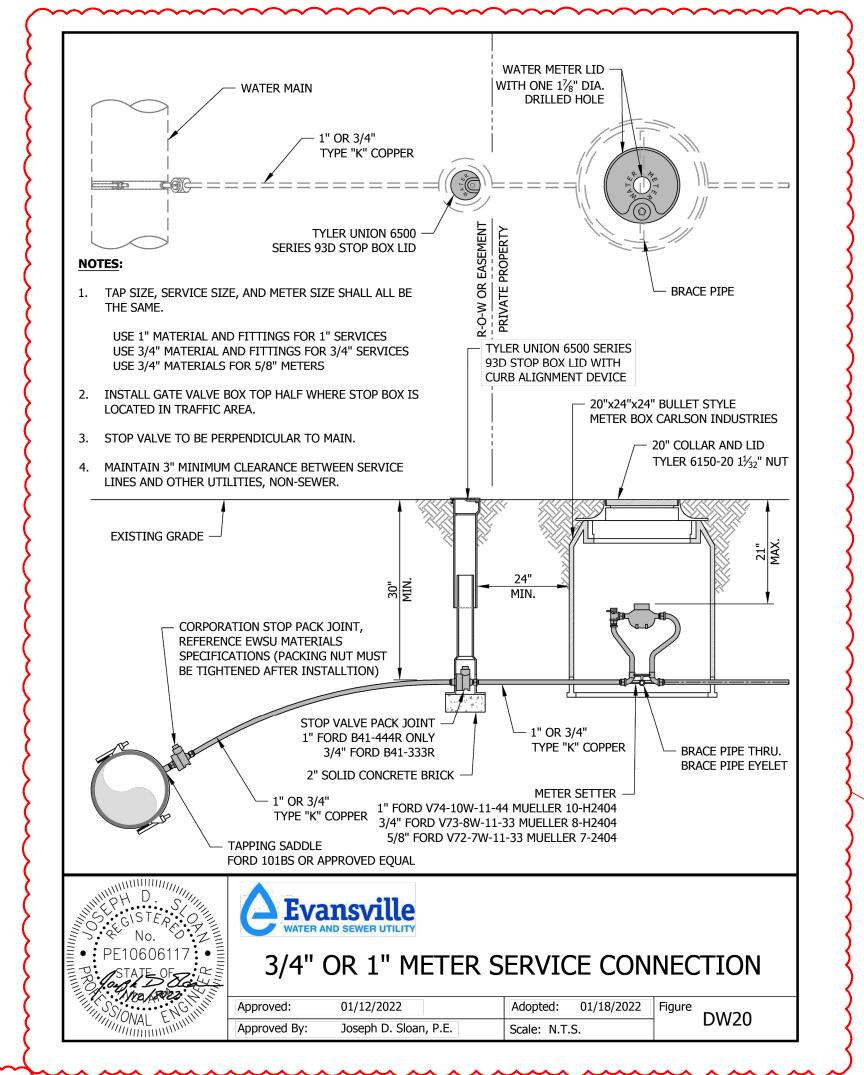
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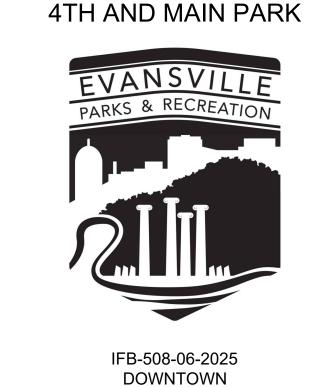








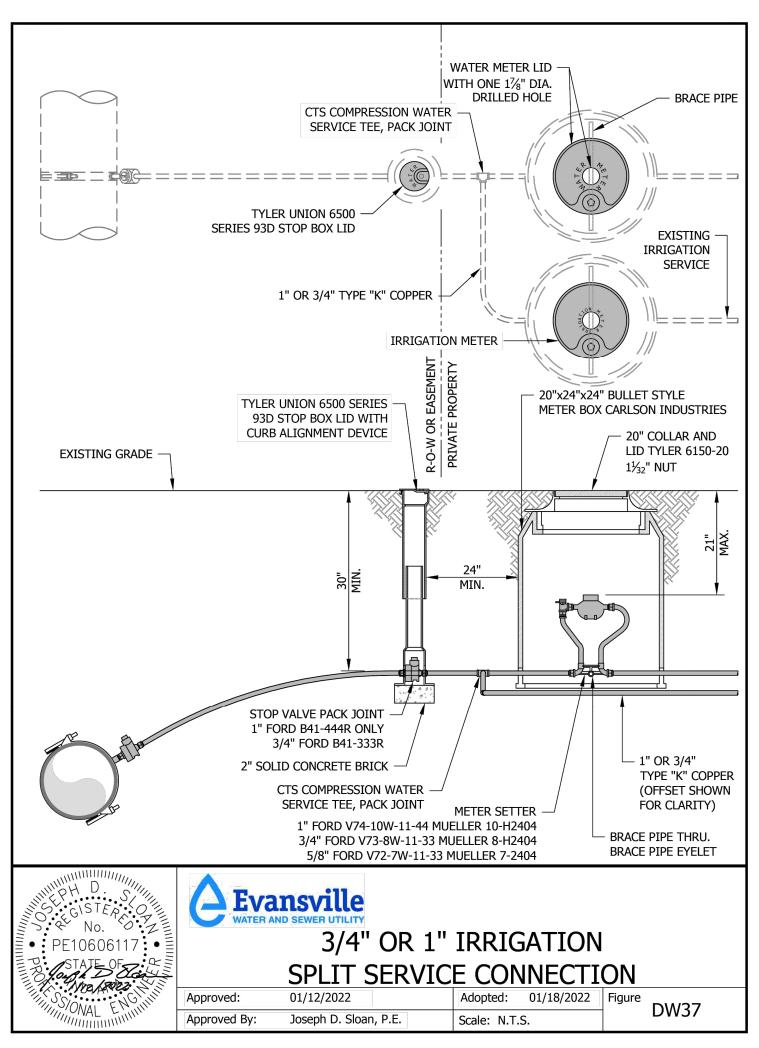

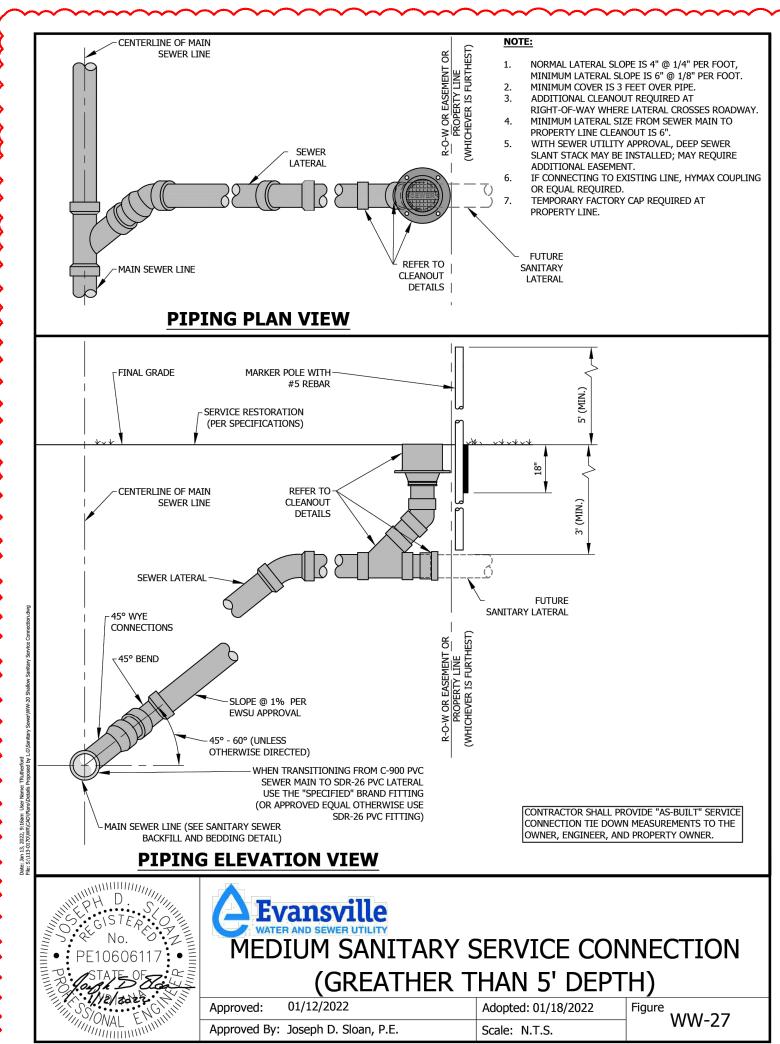

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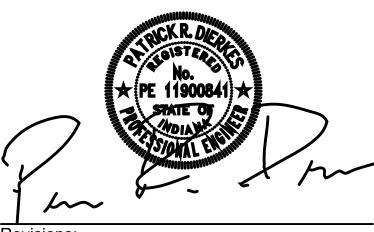
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Description Date
01 ADDENDUM # 01 09/19/2025

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Checked By:

applicable approved modifications.

Sheet title:

SITE UTILITY DETAILS

Architect's Project No:

2024-183 September 2025

Drawing No:

J202

						IG FIXT	UNE 3	CHEDUL	_		NITRO	
SYMBOL	DESCRIPTION	MANUFACTURER	FIXTURE SERIES	TYPE	QNTY PER	WATTS	FIXTURE VOLTAGE	MOUNTING -	LENS	LIGHT CO	NTROL LOUVER FINISH	REMARKS
	GENERAL RURROSE LER JET NOMINAL LOW PROFILE	LITHONIA LTG	FEM-L48-4000LM-LPAFL-WD-MVOLT- GZ10-40K-80CRI SERIES		FIXTURE			SURFACE,	ELING	TALL LLOT GIA	20072171111011	
(F1)	GENERAL PURPOSE LED 4FT NOMINAL LOW PROFILE ENCLOSED AND GASKETED LIGHTING FIXTURE WITH FIBERGLASS HOUSING AND ACRYLIC FROSTED LENS. FIXTURE DIMENSIONS: 6.8"(W) x 4.2"(D) x 51-3/4"(L). [FIXTURE LUMEN OUTPUT ~ 4000 LUMENS]	ORACLE LTG	4-OWS-LED-4000LM-DIM10-MVOLT- 40K-85CRI SERIES	LEDS 4000K (60,000 HRS WITH 80% LUMEN MAINTENANCE)	QNTY AS REQUIRED	22.1W (NOMINAL FIXTURE INPUT WATTS)	120V	CEILING (OR SUSPENDED AS NOTED ON	ACRYLIC, LOW PROFILE, FROSTED			1. PROVIDE FIXTURE WITH VANDAL RESISTANT SHIELDING AND TAMPER PROOF TORX SCREW
[FIXTURE LUMEN OUTPUT ~ 4000 LUMENS]	[FIXTORE COMEN COTT OF A 4000 COMENS]	METALUX	4APTVTLD-40L840 SERIES EVO2SQ-40/20-AR-LSS-WD-MVOLT-	WAINTENANCE)				LTG PLANS)		CLEAR		
⟨ F2 ⟩	2" SQUARE LED RECESSED CAN OPEN DOWNLIGHT RATED FOR WET LOCATIONS UNDER A CANOPY. MINIMUM PLENUM HEIGHT: 7-1/4". MAINTAINABLE FROM BELOW	GOTHAM LTG PORTFOLIO	UGZ SERIES LD2B-20-MVOLT-D010-EU2B-20FL40-	LEDS 4000K (60,000 HRS	QNTY AS	31.7W (NOMINAL		RECESSED,		METALIZED TRIM, SEMI-		PROVIDE FIXTURE WITH VANDAL RESISTANT SHIELDING. COORDINATE FIXTURE COLOR WARCHITECT PRIOR TO ORDERING.
(IZ)	A HARD CEILING. [FIXTURE LUMEN OUTPUT ~ 2000 LUMENS]	PORTFOLIO	80CRI-40K-2LB-DSQC-1-MW-HB26 SERIES	WITH 70% LUMEN MAINTENANCE)	REQUIRED REQUIRED	QUIRED FIXTURE 120V INPUT WATTS)	120V	20V CEILING		SPECULAR TRIM AND FLANGE FINISH		ARCHITECT PRIOR TO ORDERING.
	6" SQUARE LED RECESSED CAN OPEN DOWNLIGHT RATED FOR WET LOCATIONS UNDER A CANOPY. DIMMABLE DOWN TO	GOTHAM	IVO6SQ-D-30LM-40K-80CRI-MWD-MIN1- MVOLT-ZT-WL-P-AR-LSS-F SERIES	LEDS 4000K		28.3W				CLEAR METALIZED		
⟨ F3 ⟩	1% OF FULL LUMEN OUTPUT. MAINTAINABLE FROM BELOW A HARD CEILING. MAXIMUM FIXTURE HEIGHT: 7-1/4". [FIXTURE LUMEN OUTPUT ~ 2935 LUMENS]	PORTFOLIO	LDSQ6C-30-80CRI-(120-277)-D010-B26- SQ-1-H-WET LOCATION RATED SERIES	(60,000 HRS WITH 70% LUMEN MAINTENANCE)	QNTY AS REQUIRED	(NOMINAL FIXTURE INPUT WATTS)	120V	RECESSED, CEILING		TRIM, SEMI- SPECULAR TRIM AND FLANGE FINISH		
S1 ⟩	LAWN LIGHT POLE WITH TOP LIGHTING FIXTURE, TWO ADJUSTABLE FLOOD LIGHTS, BASE PLATE, POLE THICKNESS REQUIRED TO SUPPORT ALL FIXTURES, INCLUDING THE CANTENARY STRING LIGHTS AND MEDIA/SPEAKER ASSEMBLIES. PROVIDE WITH CUSTOM MODIFICATIONS REQUIRED FOR ATTACHMENT/MOUNTING OF CANTENARY STRING LIGHTS AND MEDIA/SPEAKER SUPPORT/MOUNTING. PROVIDE WITH CUSTOM PAINT FINISH COLOR. [FIXTURE LUMEN OUTPUTS:	HESS	POLE: CITY ELEMENTS 180, 16FT POLE (CE180-16), CUSTOM PAINT COLOR. HEAD: TOP ELEMENT WITH 180 DEGREE LENS (AR800-1LVC-(xx)K-T(x)-DIM), CUSTOM PAINT COLOR. LAWN FLOOD LIGHT: INTERMEDIATE ELEMENT FOR ACCENTING (BS400-L3.3-(xx)K-(xx)) FOR PERS CUSTOM PAINT COLOR.	LEDS 4000K (60,000 HRS WITH 70% LUMEN MAINTENANCE)	QNTY AS REQUIRED	1 (96W) (NOMINAL FIXTURE INPUT WATTS)	120V	POLE (SEE REMARKS)				1. SEE "LA509" SERIES DRAWING FOR ADDITIONAL REQUIREMENTS, INCLUDING BUT NOT LIM TO, PHYSICAL DIMENSIONS, EQUIPMENT MOUNTING, INSTALLATION AND POLE BASE DETAILS
	TOP ELEMENT ~ 6457 LUMENS PERFORMANCE FLOODLIGHT ~ 1950 LUMENS COMPACT FLOODLIGHT ~ 1782 LUMENS]		(xx) DEGREES, CUSTOM PAINT COLOR. PARK FLOODLIGHT: INTERMEDIATE ELEMENT FOR ACCENTING (BS400-L3.3-(xx)K-(xx)) DEGREES, CUSTOM PAINT COLOR. SPEAKER MOUNT: BH400, MODIFIED TO PUT A PLATE WITH DRILLING TO MOUNT									
	(NO SUBSTITUTES ALLOWED)		SPEAKER TO OUTSIDE AND SURGE SUPPRESSOR INSIDE, PROVIDE WATER- TIGHT WIREWAY, CUSTOM PAINT COLOR. CANTENARY STRING LIGHT MOUNT:									
\wedge			REFER TO DETAIL 4 "POST - CANTENARY CONNECTION ENLARGEMENT", SHEET LA509 REV 01, FOR REQUIREMENTS. BASE ELEMENT: EXTERNAL FLANGE WITH ANCHOR BOLTS AND BASE COVER (CR02-11-EF-ABBC), CUSTOM PAINT COLOR.									
114		BEGA	POLE: ALUMINUM POLE, CUSTOM 6" DIAMETER, HEIGHT 14 FEET (14 RFNS1 - MOD60315), CUSTOM PAINT COLOR. HEAD: POLE TOP LUMINAIRE, SYMETRIC (84 101), CUSTOM PAINT COLOR.									
			LAWN FLOOD LIGHT: PERFORMANCE FLOODLIGHT (84 217), CUSTOM PAINT COLOR.									
			PARK FLOODLIGHT: COMPACT FLOODLIGHT (77 705), CUSTOM PAINT COLOR. SPEAKER MOUNT: MOUNT SPEAKER TO OUTSIDE OF PLATE WITH CUSTOM MOUNTING PLATE, SURGE SUPPRESSOR INSIDE, PROVIDE WATER-TIGHT WIREWAY, CUSTOM PAINT COLOR.									
			CANTENARY STRING LIGHT MOUNT: REFER TO DETAIL 4 "POST - CANTENARY CONNECTION ENLARGEMENT", SHEET LA509 REV 01, FOR REQUIREMENTS. BASE ELEMENT: EXTERNAL FLANGE WITH ANCHOR BOLTS AND ROUND BASE COVER, CUSTOM PAINT COLOR.									
⟨S2⟩	WET LOCATION CANTENARY STRING LIGHTING SYSTEM, LED TRUE RGB+W, WITH BLACK WIRE COLOR AND 24" SPACING OF LUMINAIRES. PROVIDE COMPLETE WITH ALL REQUIRED ACCESSORIES INCLUDING BUT NOT LIMITED TO: POWER SUPPLIES, CONTROLLER, CABLES, STRUCTURAL CABLES, JUMPER CABLES, DMX INTERFACE EQUIPMENT, ETHERNET SWITCHES, PATCH CORDS AND ADAPTERS. PROVIDE	TIVOLI	LST-BK-24-RGBW-OP-LENGTHS AS REQUIRED-24VDC-REQUIRED ACCESSORIES				120V	POLE (SEE REMARKS)				SEE "LAXXX" SERIES DRAWINGS FOR ADDITIONAL REQUIREMENTS, INCLUDING BUT NOT LIMITED TO, PHYSICAL DIMENSIONS, EQUIPMENT MOUNTING, LUMINAIRE SPACING AND INSTALLATION DETAILS. PROVIDE LENGTH OF CANTENARY LIGHTS AS INDICATED ON THE "LAXXX" SERIES DRAWING. PROVIDE SHOP DRAWINGS WHICH INDICATE ALL INSTALLATION REQUIREMENTS. FOLLOWING.
	SYSTEM COMPLETE WITH EQUIPMENT/ACCESSORIES REQUIRED FOR BOTH ON-LINE & OFF-LINE OPERATION.											3. PROVIDE SHOP DRAWINGS WHICH INDICATE ALL INSTALLATION REQUIREMENTS, EQUIPM LOCATIONS, INTERCONNECTION & WIRING DIAGRAMS.
S3	ENCLOSURE (BUILT-IN JUNCTION BOXES & IP65 RATING) AND ALL ACCESSORIES REQUIRED FOR MOUNTING WITHIN OUTDOOR LOCATIONS AS INDICATED ON THE CONTRACT DRAWINGS.	LED LINEAR USA INC	HYDRALUX-LD5-W8-27(3800K)-IP67- REQUIRED IP67 DRIVER SERIES	LEDS 3800K (60,000 HRS WITH 80% LUMEN	QNTY AS REQUIRED	1.5W/FT (NOMINAL FIXTURE INPUT	120V	SURFACE, (BOTTOM OF STRAPS SUPPORTING BENCH SEATS				 SEE "LAXXX" SERIES DRAWINGS FOR ADDITIONAL REQUIREMENTS, INCLUDING BUT NOT LIMITED TO, LETAPE INSTALLATION LOCATION & MOUNTING DETAILS. PROVIDE SHOP DRAWINGS WHICH INDICATE ALL INSTALLATION REQUIREMENTS, EQUIPMENT LOCATION INTERCONNECTION & WIRING DIAGRAMS. INSTALL DRIVER/POWER SUPPLY WITHIN ACCESSIBLE SPACE BEHIND THE BENCH REMOVABLE WOOD PLANKS. PROVIDE A DRIVER FOR EACH PLANTER AREA FIXTURE.
	[FIXTURE LUMEN OUTPUT ~ 121LM/FT]			MAINTENANCE)		WATTS)		(SEE REMARKS)				4. PROVIDE WITH ALL REQUIRED MOUNTING ACCESSORIES, SURFACE MOUNT CLIPS, CABLES AND CONNECTORS, PROTECTION CAPS, SEALANT MATERIALS & EQUIPMENT TO PROVIDE REQUIRED IP67 INSTALLATION.
EMB2	HIGH PERFORMANCE LED EMERGENCY LIGHTING FIXTURE WITH DUAL HEADS, INTEGRAL BATTERY BACK-UP, SELF-	ISOLITE EVENLITE	BUG-6W-WH-MB-SD-BUG-ACCY-VRS SERIES TEBL6W-SD-VRWP SERIES	LEDS THREE 2W LEDS PER FIXTURE HEAD			120V	SURFACE, WALL				PROVIDE FIXTURE WITH VANDAL RESISTANT SHIELD.


THE LED ACCENT LIGHTING FIXTURES AND ASSOCIATED CIRCUITS SHALL BE INCLUDED IN THIS ALTERNATE BID ITEM.—

> SITE LIGHTING CONTROL PANEL SCHEDULE LIGHTING CONTROL PANEL "SLCP" LCP Name: PLATFORM BUILDING ELEC ROOM 201 Location: SURFACE MOUNT Surface/Flush: Power Circuit: ML1-22 (BUILDING EXTERIOR & SITE LTG) Description of Loads: Relay # Circuit Ltg Ctrl Requirements ML1-24 LAWN POLE - TOP (SEE NOTES 1 & 2) ML1-26 LAWN POLE - TOP FLOOD (SEE NOTES 1 & 2) ML1-28 LAWN POLE - LOWER FLOOD (SEE NOTES 1 & 2) ML1-30 LAWN - CANTENARY LIGHTING (SEE NOTES 1 & 2) ML1-32 BENCH LIGHTING (SEE NOTES 1 & 2) ML1-34 BENCH LIGHTING (SEE NOTES 1 & 2) SPARE 8 SPARE

(END OF LIGHTING FIXTURE SCHEDULE)

1. DUSK-TO-DAWN CONTROL VIA PHOTOCELL SENSOR. PROVIDE PHOTOCELL SENSOR ON BUILDING EXTERIOR (NORTH SIDE) AWAY FROM ALL MAN-MADE SOURCES OF DIRECT ILLUMINATION. COORDINATE THE REQUIRED INSTALLATION LOCATION IN FIELD WITH THE REQUIREMENTS OF ALL OTHER TRADES INVOLVED ON THIS PROJECT.

2. TIMED CONTROL VIA INTEGRAL 24-HOUR TIMER. CIRCUIT SHALL BE CAPABLE OF BEING DE-ENERGIZED AT A SCHEDULED EVENING TIME AS SPECIFIED BY OWNER.

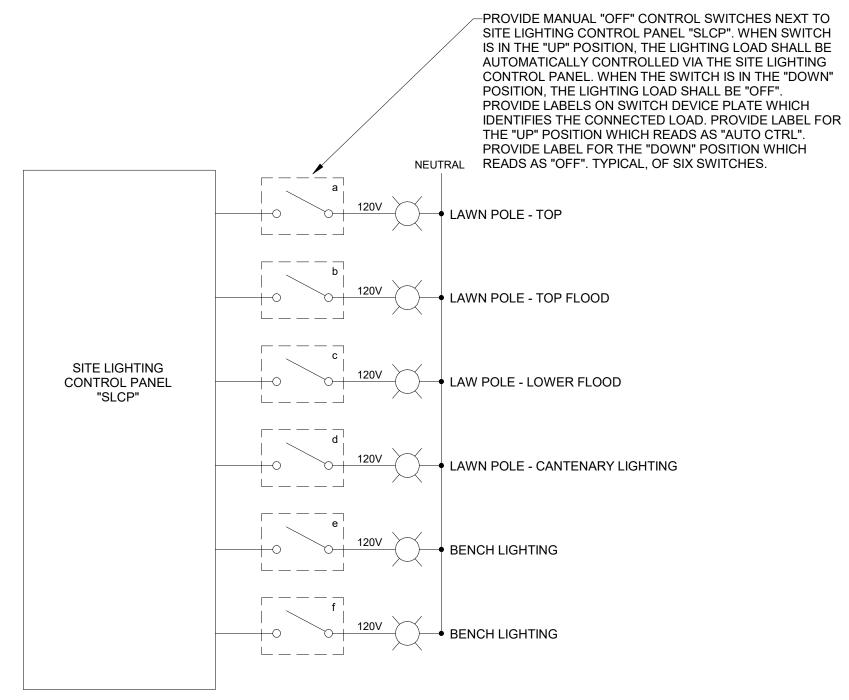

SITE LIGHTING CONTROL PANEL DIAGRAM
NO SCALE

4TH & MAIN PARK



4TH & MAIN STREET DOWNTOWN EVANSVILLE, INDIANA

Suite 800 architects • designers • engineers F: 812.421.6776

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STATE OF

#		Description		Date
1	ADDENDUM	001		Date 1
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BJH		BJH		ВЈН
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Sheet title: LIGHTING FIXTURE

Architect's Project No:

2404-183

August, 2025

Date:

Drawing No:

SCHEDULE